Village of Tinley Park

News Release



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Village releases FAQ sheet for proposed Reserve development

The Village of Tinley Park has received many questions related to the Reserve, a proposed 47unit multifamily residential building at the northeast corner of 183rd Street and Oak Park Avenue. In response, the Village has issued the following list of frequently asked questions about the development:

1. What is the Reserve?

The Reserve is a 47-unit multifamily residential development proposed to be located at the northeast corner of 183rd Street and Oak Park Avenue, adjacent to the Eagle's Nest.

2. Who is the developer of the Reserve?

The developer is Buckeye Hope Community Foundation (<u>www.buckeyehope.org</u>), a nonprofit community housing developer based in Ohio that has experience in developing residential housing.

3. Is this a "public housing project?"

No. This development is not owned or administered by a government agency. The development is designed to provide options for working individuals and families who meet strict criteria but who are generally priced out of the local housing market. It is especially helpful to young workers, seniors and families who want to put down roots in or remain in a community like Tinley Park. The Reserve is more comparable to existing Village residential developments like Brementowne Manor, which offers subsidized housing to senior citizens.

4. Has the developer been given any variations or exceptions from Village codes or ordinances?

The development as proposed meets and exceeds Village codes and ordinances, including the high standards for building materials, life safety and landscaping. No exceptions have been requested or provided.

DATE: January 26, 2016

5. Has the development received any incentives from the Village?

No. The developer has not asked for or received any incentives from the Village of Tinley Park. No Village funds will be provided and the development will pay property taxes, building permit fees and impact fees.

6. When was this development proposed to the Village?

After some consultations with the Village to review applicable codes and ordinances the developer formally submitted design and engineering plans in October 2015.

Additionally, the Reserve development had a long application process with the Illinois Housing Development Authority (IDHA) to obtain tax credit. The Village was in communication with the developer during these early stages to review conceptual plans. The Village issued a preliminary zoning compliance letter and a letter indicating compliance to the Village Master Plan.

All reviewing departments (Building, Public Works, Police, Fire, Engineering and Planning) completed their code reviews in December 2015, and Planning Department staff prepared a staff report for Plan Commission review in mid-January 2016.

7. What is the approval process for the Reserve development?

Since the property is already zoned for multi-family residential use, the development does not require any approval by the Village Board. However, the Reserve does require that the Village Plan Commission determine that the plan complies with relevant Village standards.

The Village's review of the development indicates that the plans meet or exceed Village requirements for size, appearance, traffic management, safety, landscaping and compatibility with the long-range plans for land use.

It is likely the Plan Commission will vote on the site plan approval for the development at its regular meeting on Feb. 4, 2016.

8. What will the building look like?

- The exterior will feature face brick, smooth faced stone and Hardie board (a cementitious siding product) in quantities that meet the Legacy Code building material standards.
- The site will include bike parking, interior to the building and within the site; a small retention pond area; landscaped open space; and a small "tot lot."
- The site is well-landscaped and exceeds Village landscape requirements.
- The developer will fully sprinkle the building and meet the International Building Codes and the Tinley Park Building Code.
- Required parking for residents (one space per unit) will be located at the rear of the building, underneath the second story of the building, and meets the Legacy Code

requirements. Required guest parking is provided at the rear of the building in a parking lot.

• See the below photo for a rendering of the development. Other information, including site plans, documents and additional renderings, are included at the conclusion of the FAQ sheet.



9. Will this development be regularly inspected?

Yes. As with all of the single-family and multiple-family rental products within the community, this development will be included in the Tinley Park Crime Free Rental Housing Program. The program is designed to combat and eradicate criminal activity in rental properties. It monitors tenant conduct and, if necessary, provides a mechanism to remove those problem tenants from their leased properties.

In addition, the Village Board is studying the possibility of a regular rental inspection program.

10. How is this development funded?

Tax credit financing means the development was granted a "federal income tax credit" by the State of Illinois that can be sold at market to offset federal income tax liabilities. The proceeds from the sale of tax credits are used as equity by the developer.

The developer sells its Low Income Housing Tax Credit (LIHTC) on the open market. That revenue allows the developer to build a higher-quality community while keeping rental prices affordable.

The Village was not part of the developer's application to the Illinois Housing Development Authority (IDHA). The developer received approval for a Low Income Housing Tax Credit (LIHTC) through IDHA in fall of 2015.

The below chart, provided by the developer, indicates the required household income limits for this development (based upon 2014 numbers).

THE RESERVE AT TINLEY PARK GROSS RENT AS A PERCENT OF INCOME

Income and Rent	1 Person Household	2 Person Household	3 Person Household	4 Person Household	5 Person Household	6 Person Household
Very Low-Income (50% of Median)	\$26,600	\$30,400	\$34,200	\$38,000	\$41,050	\$44,100
1 Bedroom Units						
Proposed Rent Plus Utilities	\$6 77	\$677	-		-	-
Rent as % of Maximum Income	30.5%	26.7%	-		.=	-
Minimum Income Needed for Affordability*	\$23,211	\$23,211			₫.	
Maximum Allowable Rent (LIHTC)	\$712	\$712	2	-	<u>.</u>	-
2 Bedroom Units						
Proposed Rent Plus Utilities	\$812	\$812	\$812	\$812		÷
Rent as % of Maximum Income	36.6%	32.1%	28.5%	25.6%	-	-
Minimum Income Needed for Affordability*	\$27,840	\$27,840	\$27,840	\$27,840	-	-
Maximum Allowable Rent (LIHTC)	\$855	\$855	\$855	\$855	-	-
3 Bedroom Units						
Proposed Rent Plus Utilities	\$939	\$939	\$939	\$939	\$939	\$939
Rent as % of Maximum Income	42.4%	37.1%	32.9%	29.7%	27.4%	25.6%
Minimum Income Needed for Affordability*	\$32,194	\$32,194	\$32,194	\$32,194	\$32,194	\$32,194
Maximum Allowable Rent (LIHTC)	\$988	\$988	\$988	\$988	\$988	\$988
Low-Income (60% of Median)	\$31,920	\$36,480	\$41,040	\$45,600	\$49,260	\$52,920
1 Bedroom Units						
Proposed Rent Plus Utilities	\$812	\$812	-	(•)	-	-
Rent as % of Maximum Income	30.5%	26.7%	-	-		-
Minimum Income Needed for Affordability*	\$27,840	\$27,840	-	1.51		-
Maximum Allowable Rent (LIHTC)	\$855	\$855	2	- <u>-</u>	12	-
2 Bedroom Units						
Proposed Rent Plus Utilities	\$975	\$975	\$975	\$975		2
Rent as % of Maximum Income	36.7%	32.1%	28.5%	25.7%	4	-
Minimum Income Needed for Affordability*	\$33,429	\$33,429	\$33,429	\$33,429	-	-
Maximum Allowable Rent (LIHTC)	\$1,026	\$1,026	\$1,026	\$1,026	-	-
3 Bedroom Units						
Proposed Rent Plus Utilities	\$1,127	\$1,127	\$1,127	\$1,127	\$1,127	\$1,127
Rent as % of Maximum Income	42.4%	37.1%	33.0%	29.7%	27.5%	25.6%
Minimum Income Needed for Affordability*	\$38,640	\$38,640	\$38,640	\$38,640	\$38,640	\$38,640
Maximum Allowable Rent (LIHTC)	\$1,185	\$1,185	\$1,185	\$1,185	\$1,185	\$1,185

* Gross Rent includes all utilities. Utility allowance is : 1 BR: \$171; 2 BR: \$210; 3 BR: \$250

Note: Minimum income for affordability assumes 35% of income for rent. All 30% AMI and some 50% AMI units will have project-based vouchers so that tenants will pay 30% of their income in rent.

Source: Valerie S. Kretchmer Associates, Inc.

11. What is the market for affordable housing?

The Reserve is designed to appeal to working individuals and families who must meet stringent requirements for credit-worthiness, and will be subject to a rigorous background check.

12. What is the tenant selection process?

Should the project be approved, community organizations such as the Ministerial Association would help to identify Tinley Park residents who would quality for the program.

The standards from the developer's Tenant Selection Plan include:

All applicants for housing will be screened according to the criteria set forth in the Admission Standards. These criteria are:

- Past performance in meeting financial obligations, especially rent
- Absence of bad record of residency such as destruction of property, disturbance to neighbors
- No evidence of poor housekeeping habits
- No involvement in criminal activities, including but not limited to felonies, in the past 60 months
- No record of evictions or terminations from housing programs and private landlords
- Applicant's ability and willingness to comply with the lease
- No misrepresentation of any information related to eligibility, income, household composition, previous landlords etc.
- Applicants must be of legal age to enter a lease.

Criminal history reports will be investigated for each applicant household member age 18 or older. Screening for criminal offenses will be subject to denial if they are related to sexual offences, drugs and violence. Standards prohibit admission of:

- **Illegal drugs:** Any household containing a member(s) who was evicted in the last three years from federally assisted housing for drug-related criminal activity will be denied admission. Households in which any member is currently engaged in illegal use of drugs or for which the owner/agent has reasonable cause to believe that a member's illegal use or pattern of illegal use of a drug may interfere with the health, safety and right to peaceful enjoyment of the property by other residents also will be denied admission.
- **Sexual offenders:** Any household member who is subject to any state sexual offender registration requirement will be denied admission.
- Violence and violent crime: Households containing a member that has a history of violence against other persons and/or who have been convicted of a crime using a weapon against another individual will be denied admission.
- Alcoholism behavior: Any household member's behavior, from alcoholism abuse that may have led to violent or offensive behavior and/or crime that will interfere with

the health, safety and right to peaceful enjoyment by other residents, will be denied admission. The screening standards must be based on alcoholism behavior, not a medically diagnosed condition of alcoholism or alcohol abuse.

- **Felony conviction:** Any household containing a member who has a felony conviction for any type of crime that is less than seven years old will be subject to denial.
- **Misdemeanor conviction:** Households with members who have a misdemeanor conviction or are a habitual offender with misdemeanor convictions that relate to sexual offenses, drugs or violence will be subject to denial. Examples include public intoxication, disorderly conduct, menacing, soliciting prostitution and vandalism.
- **Criminal offense against employees and property:** Households with members who have at any time have committed other criminal activity that would threaten the health, safety of the owner or any employee, contractor, subcontractor or agent will be denied admission.

14. Will this development hurt my property values?

Market valuation for houses is based primarily on comparables (nearby houses of similar size, school quality, tax rates and community economic strength). Similarly, market values for apartments are valued based on comparable rental developments and are not affected by senior housing, assisted living apartments, subsidized/tax credit financed housing or single-family residential.







DATE

PROJECT: THE RESERVE AT TINLEY PARK NEC OF OAK PARK AV AND 183RD ST TINLEY PARK, IL BUCKEYE COMMUNITY HOPE FOUNDATION 3021 E DUBLIN-GRANVILLE RD COLUMBUS, OH 43231


JOB NO. 15-016 DATE 12-5-15 FILE PLOT SCALE 1:1 OWNER APPROVAL

SHEET TITLE

PERSPECTIVE

SHEET NUMBER

A5.2

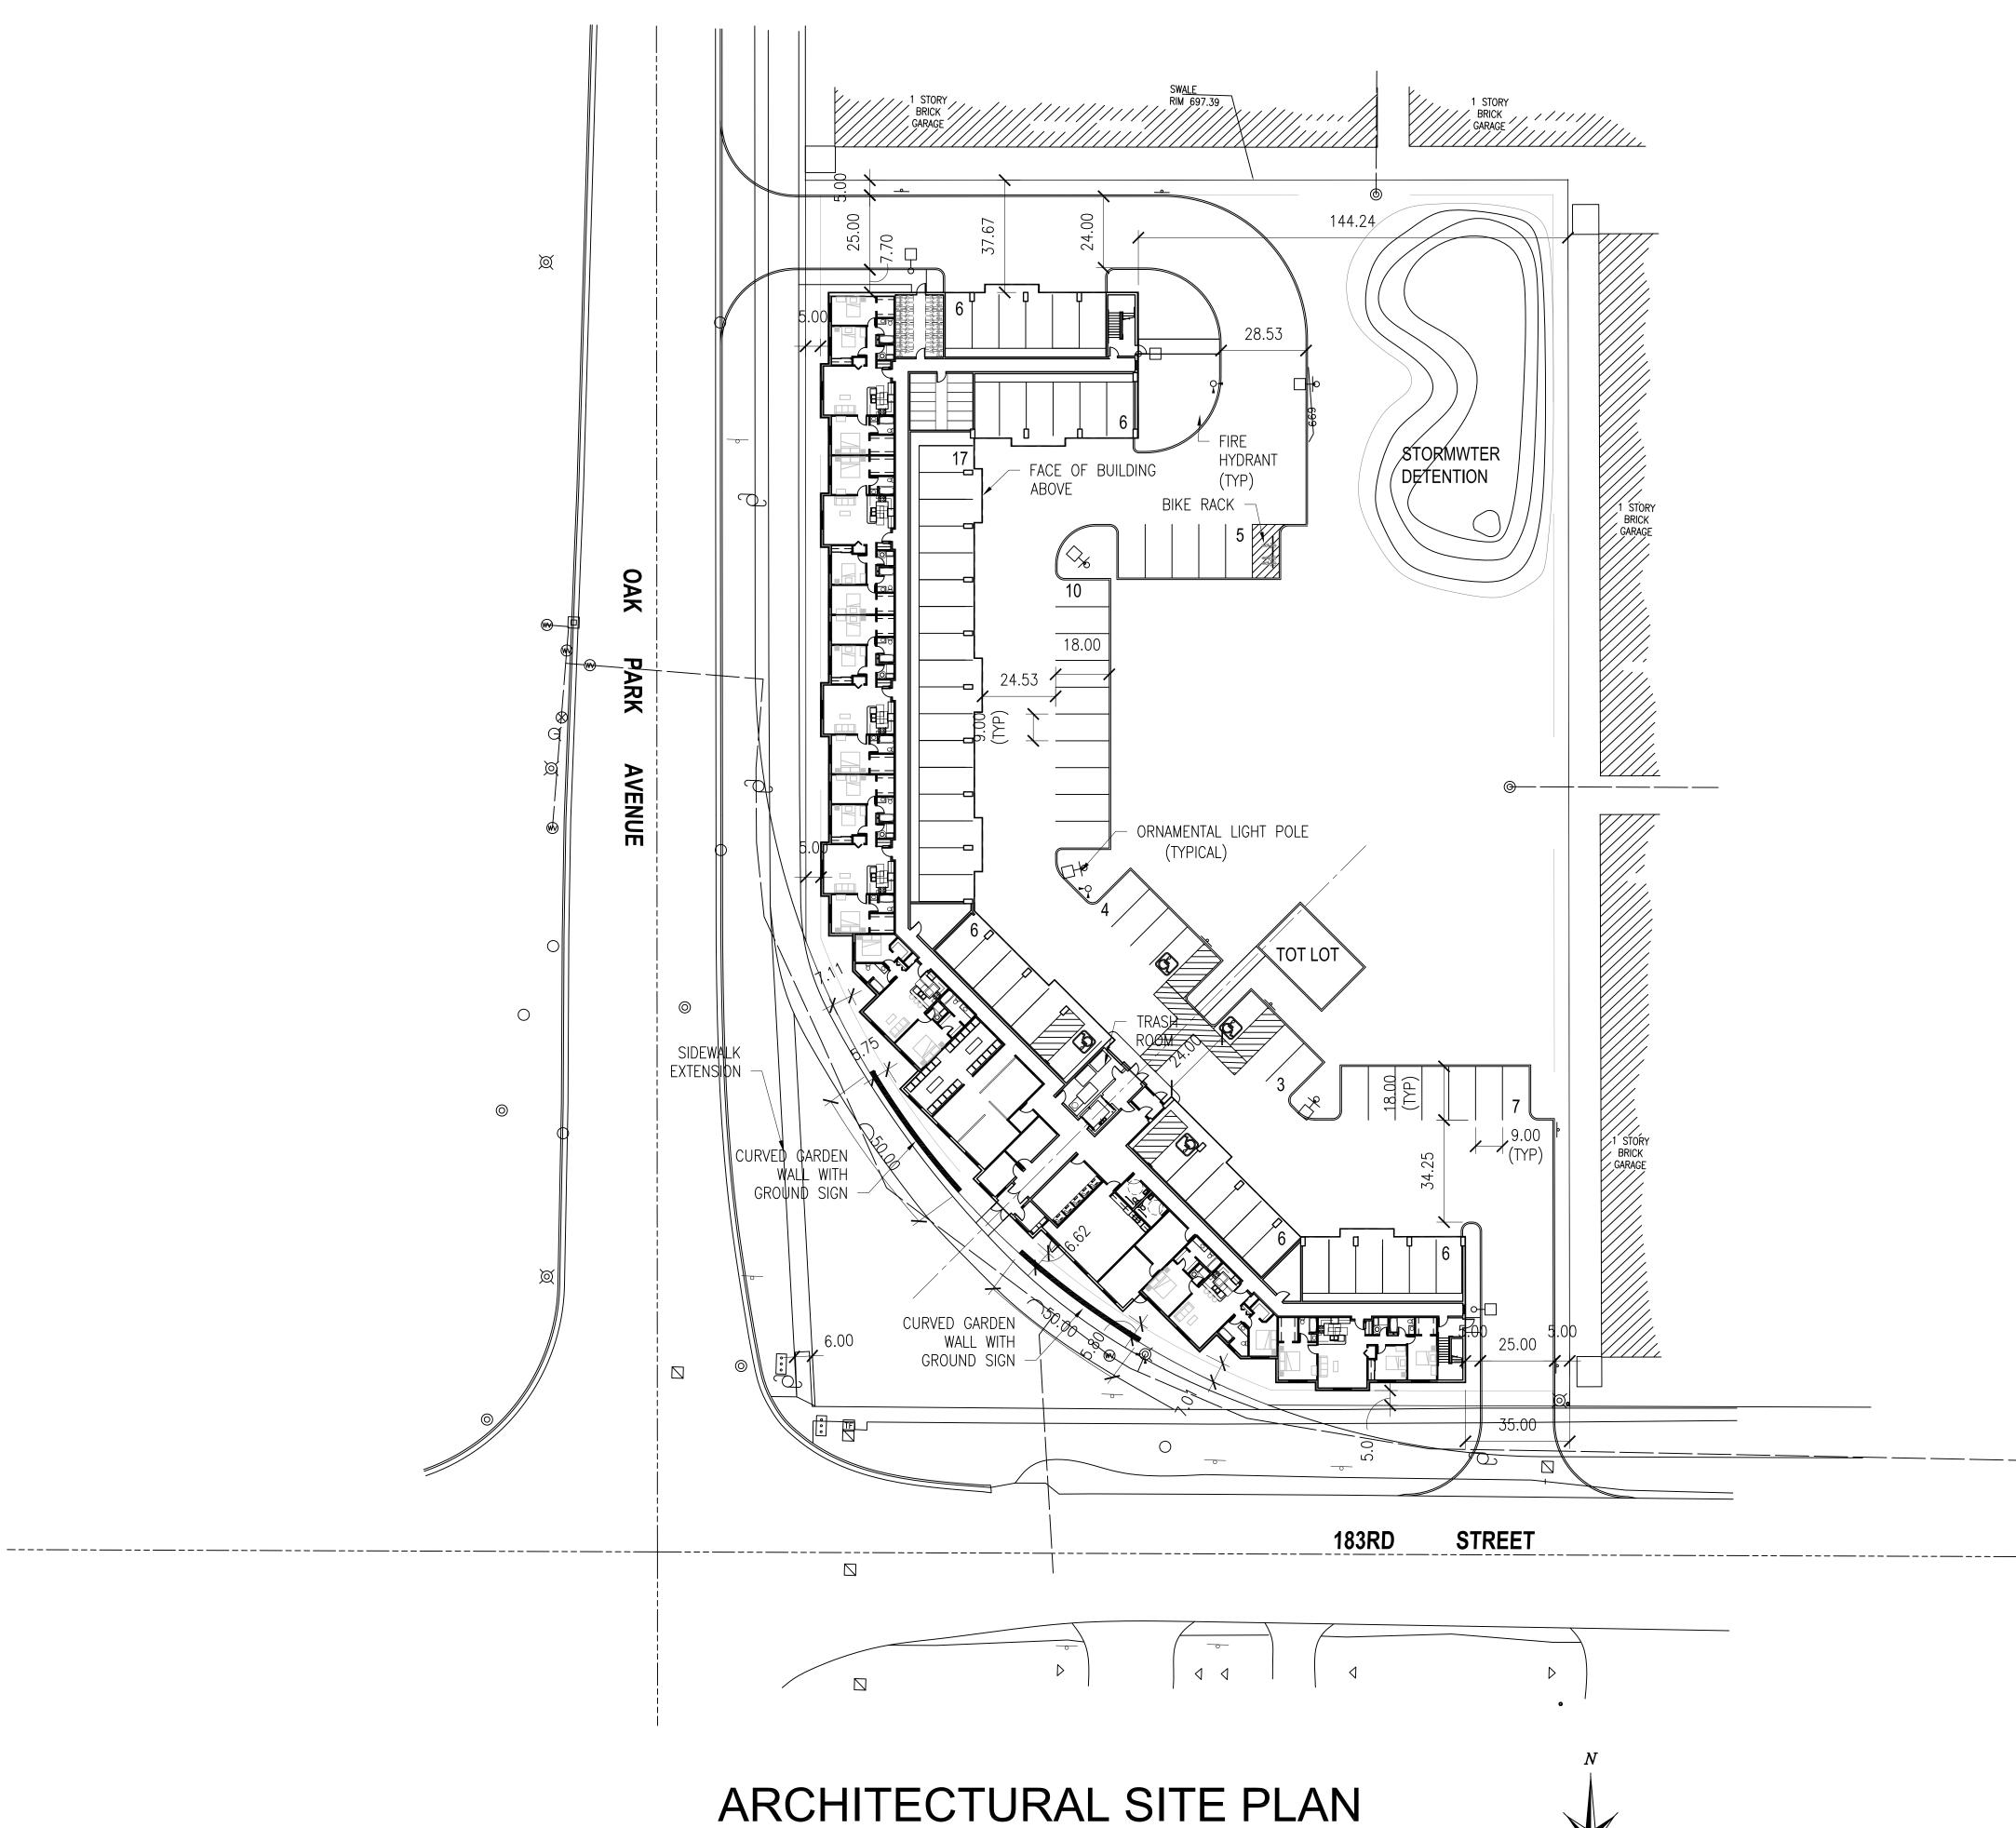

SCALE: 1" = 30'

NOTES

		SITE DATA		
		GENERAL		
Frontage:	Ft:	583.34		
Gross Site Area:		96789.56	Acres:	2.22
	COVER	AGE AND DENSITY		
Building Coverage:	28%			
Floor Area Ratio (FAR):	0.83			
Density	21.2	Units per acre		
,				
Landscaped Area:	Sa. Ft:	43109.96	Percent of Site:	45%
Pavement / Building Area:		53679.6	Percent of Site:	
		55075.0	Tercent of site.	5570
			Percent of Parking	
Parking Lot Landscaping	Sq. Ft:	1295.92	Area:	19.10%
	•	PARKING		
		REQUIRED		
	Residents	Guests	Administration	Total
	Units	Units	Sq Ft	
Units or Square Footage	47	47	257	
Ratio/Unit or 1000 sf:	1	0.5	4	
Total Stalls Required:	47	24	2	73
		PROVIDED		
	Covered	Outside	Total	
Standard	45	27	72	
Accessible	2	2	4	Excess Stalls:
Total	47	29	76	3
	BUI	LDING DATA		
		LDING DATA	1	
			Common	Total
1st floor	ARE Residential 8005	AS BY FLOOR	Common	Total 26812
1st floor 2nd floor	ARE Residential	AS BY FLOOR	Common	
	ARE Residential 8005	AS BY FLOOR	Common	26812
2nd floor	ARE Residential 8005 21335	AS BY FLOOR	Common	26812 26812
2nd floor 3rd floor Total of All Floors	ARE Residential 8005 21335	AS BY FLOOR	Common Common O	26812 26812
2nd floor 3rd floor	ARE Residential 8005 21335 21335 21335	AS BY FLOOR Circulation		26812 26812 26812
2nd floor 3rd floor Total of All Floors	ARE Residential 8005 21335 21335 21335 50675	Circulation	0	26812 26812 26812 80436
2nd floor 3rd floor Total of All Floors	ARE Residential 8005 21335 21335 21335 50675 63%	Circulation	0	26812 26812 26812 80436
2nd floor 3rd floor Total of All Floors	ARE Residential 8005 21335 21335 21335 50675 63%	AS BY FLOOR Circulation	0	26812 26812 26812 80436
2nd floor 3rd floor Total of All Floors	ARE Residential 8005 21335 21335 21335 50675 63% UNIT 1	Circulation Circulation	0	26812 26812 26812 80436 1711
2nd floor 3rd floor Total of All Floors % / Total Area per Unit 1st floor	ARE Residential 8005 21335 21335 21335 50675 63% UNIT 1 1-Bedroom	Circulation Circulation 0 0%	0 0% 3-Bedroom	26812 26812 26812 80436 1711 Total All Units
2nd floor 3rd floor Total of All Floors % / Total Area per Unit 1st floor 2nd floor	ARE Residential 8005 21335 21335 21335 50675 63% UNIT 1 1-Bedroom 0	AS BY FLOOR Circulation Circul	0 0% 3-Bedroom 5	26812 26812 26812 80436 1711 Total All Units 7
2nd floor 3rd floor Total of All Floors % / Total Area per Unit	ARE Residential 8005 21335 21335 21335 50675 63% UNIT 1 1-Bedroom 0 5	AS BY FLOOR Circulation Circulation 0 0% CYPES BY FLOOR 2-Bedroom 2 4	0 0% 3-Bedroom 5 11	26812 26812 26812 80436 1711 Total All Units 7 20
2nd floor 3rd floor Total of All Floors % / Total Area per Unit 1st floor 2nd floor	ARE Residential 8005 21335 21335 21335 50675 63% UNIT 1 1-Bedroom 0 5	AS BY FLOOR Circulation Circulation 0 0% CYPES BY FLOOR 2-Bedroom 2 4	0 0% 3-Bedroom 5 11	26812 26812 26812 80436 1711 Total All Units 7 20 20
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2nd floor 3rd floor Total of All Floors % / Total Area per Unit 1st floor 2nd floor 3rd floor Total of All Floors	ARE Residential 8005 21335 21335 21335 21335 50675 63% UNIT 1 63% UNIT 1 1-Bedroom 0 5 5 5 10 10 10	AS BY FLOOR Circulation Circulation 0 0% 0% CYPES BY FLOOR 2-Bedroom 2 4 4 4	0 0% 3-Bedroom 5 11 11 11 27	26812 26812 26812 80436 1711 Total All Units 7 20 20 20 0
2nd floor 3rd floor Total of All Floors % / Total Area per Unit 1st floor 2nd floor 3rd floor Total of All Floors	ARE Residential 8005 21335 21335 50675 63% 50675 63% UNIT 1 63% 505 5 10 10 21%	AS BY FLOOR Circulation Circulation 0 0 0% CYPES BY FLOOR 2-Bedroom 2 4 4 4 10 21%	0 0% 3-Bedroom 5 11 11 11 27	26812 26812 26812 80436 1711 Total All Units 7 20 20 20 0
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2nd floor 3rd floor Total of All Floors % / Total Area per Unit 1st floor 2nd floor 3rd floor Total of All Floors % of Total Units Unit Type	ARE Residential 8005 21335 21335 21335 50675 63% UNIT 1 0 5 5 10 21% RENTA	AS BY FLOOR Circulation Circulation 0 0 0% CYPES BY FLOOR 2-Bedroom 2 4 4 4 4 10 21% BLE FLOOR AREA Floor Area per Unit	0 0% 3-Bedroom 5 11 11 27 57% Total Floor Area	26812 26812 26812 80436 1711 Total All Units 7 20 20 20 0
2nd floor 3rd floor Total of All Floors % / Total Area per Unit 1st floor 2nd floor 3rd floor Total of All Floors % of Total Units Unit Type 1-Bedroom Type A	ARE Residential 8005 21335 21335 21335 21335 35 63% UNIT 1 63% UNIT 1 1-Bedroom 0 5 5 5 1 10 21% RENTA Number of Units 6	AS BY FLOOR Circulation Circulation 0 0 0% CVPES BY FLOOR 2-Bedroom 2 4 4 4 10 21% BLE FLOOR AREA Floor Area per Unit 828	0 0% 3-Bedroom 5 11 11 11 27 57% 57%	26812 26812 26812 80436 1711 Total All Units 7 20 20 20 0
2nd floor 3rd floor Total of All Floors % / Total Area per Unit 1st floor 2nd floor 3rd floor Total of All Floors % of Total Units Unit Type 1-Bedroom Type A 1-Bedroom Type B	ARE Residential 8005 21335 21335 21335 21335 50675 63% UNIT 1 0 5 5 10 21% RENTAI Number of Units 6 4	AS BY FLOOR Circulation Circulation 0 0 0% VPES BY FLOOR 2-Bedroom 2 4 4 4 4 10 21% BLE FLOOR AREA Floor Area per Unit 828 898	0 0% 3-Bedroom 5 11 11 27 57% Total Floor Area 4968 3592	26812 26812 26812 80436 1711 Total All Units 7 20 20 20 0
2nd floor 3rd floor Total of All Floors % / Total Area per Unit 1st floor 2nd floor 3rd floor Total of All Floors % of Total Units Unit Type 1-Bedroom Type A 1-Bedroom Type A	ARE Residential 8005 21335 21335 21335 50675 63% UNIT 1 63% UNIT 1 1-Bedroom 0 5 5 10 21% RENTAI Number of Units 6 4 4	AS BY FLOOR Circulation Circulation 0 0 0% VPES BY FLOOR 2-Bedroom 2 4 4 4 10 21% BLE FLOOR AREA Floor Area per Unit 828 898 1033	0 0% 3-Bedroom 5 11 11 27 57% 57% Total Floor Area 4968 3592 4132	26812 26812 26812 80436 1711 Total All Units 7 20 20 20 0
2nd floor 3rd floor Total of All Floors % / Total Area per Unit 1st floor 2nd floor 3rd floor Total of All Floors % of Total Units Unit Type 1-Bedroom Type A 1-Bedroom Type A 2-Bedroom Type B	ARE Residential 8005 21335 21335 21335 21335 50675 63% UNIT 1 0 5 5 5 10 21% RENTA Number of Units 6 4 4 6	AS BY FLOOR Circulation Circulation 0 0% 0% 0% 2 4 2 4 10 21%	0 0% 3-Bedroom 5 11 11 27 57% Total Floor Area 4968 3592 4132 6360	26812 26812 26812 80436 1711 Total All Units 7 20 20 20 0
2nd floor 3rd floor Total of All Floors % / Total Area per Unit 1st floor 2nd floor 3rd floor Total of All Floors % of Total Units Unit Type 1-Bedroom Type A 1-Bedroom Type A	ARE Residential 8005 21335 21335 21335 50675 63% UNIT 1 63% UNIT 1 1-Bedroom 0 5 5 10 21% RENTAI Number of Units 6 4 4	AS BY FLOOR Circulation Circulation 0 0 0% VPES BY FLOOR 2-Bedroom 2 4 4 4 10 21% BLE FLOOR AREA Floor Area per Unit 828 898 1033	0 0% 3-Bedroom 5 11 11 27 57% 57% Total Floor Area 4968 3592 4132	26812 26812 26812 80436 1711 Total All Units 7 20 20 20 0



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PROJECT: THE RESERVE AT TINLEY PARK	TINLEY PARK, IL	CLIENT: BUCKEYE COMMUNITY HOPE FOUNDATION 3021 EAST DUBLIN-GRANVILLE RD COLUMBUS OH 43231
JOB NC DATE FILE PLOT S OWNER	1 A CALE 1	
Signature	-	Date
	HEET T CHITE(SITE F	CTURAL
SH		umber

ZONING TABLE Ref: 2011 Legacy Code PRINCIPAL BUILDING DESIGN STANDARDS

				rements
		Units	Current Zoning	Proposed Project
	7 . 0			
Zone	Zoning District Zoning Description		The Neighborhood Flex District co building scales, with buildings desi	gned for residential or commercial street tree plantings, and buildings
	I	1		
Use	Permitted Uses		Owner- and renter-occupied dwelling units located within single-family detached, single-family at-tached, multi-family, and/or mixed-use structures, and including but not limited to senior housing.	Multi-Family Housing
			ble 2.E.6	
	And the second state life	-	eneral	250
LT.	Minimum Lot Width	ft	20	256
Lot	Maximum Lot Width	ft	n/a 2 stories	411.72
	Minimum Building Height		2 stories	3 stories
		Buildir	ng Setbacks	
	Front setback, minimum	ft	5	5
≥ ag	Front setback, maximum	ft	15	13.25
Primary Frontage	Secondary street setback, minimum	ft	5	5
<u>م ت</u>	Secondary street setback, maximum	ft	15	6.95
ac	Interior Side Setback, maximum	ft	5	n/a
Side Setbac k	Access Drive Side Setback, minimum	ft	5	5
~	Rear alley setback, minimum	ft	5	n/a
Rear Setback	No alley setback, minimum	ft	5	145.22
Š	Future alley setback, minimum	ft	30	n/a
	r	_	g Setbacks	
	Front setback, minimum	ft	25	45.74
Primary Frontage	Front setback, maximum	ft	n/a	n/a
Prii Froi	Secondary street setback, minimum	ft	10	36.95
	Secondary street setback, maximum	ft	n/a	n/a
		1.0		1 /
Side Setbac k	Interior Side Setback, maximum	ft	0	n/a
τ, γ	Access Drive Side Setback, minimum	ft	5	5
	Rear alley setback, minimum	ft	5	n/a
Rear Setback	No alley setback, minimum	ft	5	34.25
Re Sett	Future alley setback, minimum	ft	30	n/a
			30	11/4
		Alley & Acce	I	
	Alley Rear Yard Setback, minimum		5	n/a
	Alley Location		n/a	n/a
	Access Road Location	-	As per page 61	
		1		1
	Permitted location of accessory structures		Parking zone	n/a







REVISIONS



JOB NO. 15-016 DATE 12-5-15 FILE PLOT SCALE 1:1 OWNER APPROVAL

SHEET TITLE PERSPECTIVE

SHEET NUMBER

A5.3







PROJECT: THE RESERVE AT TINLEY PARK NEC OF OAK PARK AV AND 183RD ST TINLEY PARK, IL CLIENT: BUCKEYE COMMUNITY HOPE FOUNDATION 3021 E DUBLIN-GRANVILLE RD COLUMBUS, OH 43231

JOB NO. 15-016 DATE 12-5-15 FILE PLOT SCALE 1:1 OWNER APPROVAL

SHEET TITLE PERSPECTIVE

Date

SHEET NUMBER

A5.4

Landscape Plai <u>CODE</u>	<u>QTY</u>	<u>SIZE</u>	SCIENTIFIC NAME	COMMON NAME	<u>NOTES</u>	
SHADE/ORNAN Acar	VENTAL 1 4		Acer rubrum 'Armstrong'	Armstrong Upright Maple	Single leader	
Acgi	5	2.5 cal. 6 ft.	Acer ginnala	Amur Maple	Full clump	
Acru	8	2.5" Cal.	-	October Glory Red Maple	Balled and Burlapped	STORMWATER
Acsa	6		Acer saccharum 'Green Mountain'	Green Mountain Sugar Maple	Balled and Burlapped	
Amla	6	6 ft.	Amelanchier laevis	Serviceberry	Full clump	TO ELEVATIO
leni	7	6 ft.	Betulus nigra 'Heritage'	Heritage River Birch	At least 3 stems	
ceca Coma	8 12	6 ft. 6 ft.	Cercis canadensis Cornus mas	Redbud Corneliancherry Dogwood	Northern Illinois grown Full clump	
itu	5		Liriodendron tuliperfa	Tuliptree	Balled and Burlapped	
lasa	10	2.5 cal. 6 ft.	Malus sargentii	Sargent Crabapple	Full clump	
last	7	6 ft.	Magnolia stellata	Star Magnolia	Full clump	
yfa	5	2.5" Cal.	Pyrus fauriei	Koreansun Pear	Straight leader	
ubi	5			Swamp White Oak	Balled and Burlapped	
uma	6		Quercus macrocarpa	Bur Oak	Balled and Burlapped	
uro	3		Quercus robur 'Fastigata'	Upright English Oak	Matched	
re	5	2.5" Cal.	Syringa reticulata 'Ivory Silk'	Ivory Silk Japanese Tree Lilac	Straight leader	
/ERGREEN TI ၁co	2 2	6 ft.	Abies concolor	Concolor Fir	Straight leader	
ab	1	6 ft.	Picea abies	Norway Spruce	Single leader	
ab adi	3	6 ft.	Taxodium distichum	Bald Cypress	Single, Straight leader	
IRUBS	5	0 m.		Sara Sthices	onder on anglic leader	
me	13	5 Gal.	Aronia melanocarpa	Black Chokeberry	24" tall; full plants	
se	37	5 Gal.	Cornus sericea 'Isanti'	Isanti Redtwig Dogwood	24" tall	10-Vide
/pa	40	3 Gal.	Hydrangea paniculata 'Tardiva'	Panicle Hydrangea	Full plant	
ar	11	2 Gal.	Rhus aromatica 'Gro Lo'	Gro Low Fragrant Sumac	Full container	
са	25	5 Gal.	Sambucus canadensis 'Black Lace'	Black Lace Elderberry	Full plant	6-Rhar
bu	22	5 Gal.	Spirea x bumalda 'Anthony Waterer'	Anthony Waterer Spirea	24" wide	6-Rhar -
rpa I	41	5 Gal.	Syringa patula	Miss Kim Lilac	24" tall	
la tr	26 10	5 Gal.	Viburnum lantana 'Mohican' Viburnum trilobum	Mohican Viburnum	24" tall	To
de	19 32	5 Gal. 5 Gal.	Viburnum dentatum	Highbush Cranberry Viburnum Arrowwood Viburnum	24" tall 30" tall	
ue /ERGREEN SH		5 Gai.	Vibanian dentatum	Anowwood vibaniani	50 (a)	3-Sypa
ch	26	5 Gal.	Juniperus chinensis 'Sea Green'	Sea Green Juniper	24" wide	
mu	26	3 Gal.	· Pinus mugo 'Slowmound'	Dwarf Mugo Pine	Full plant	
ame	30	5 Gal.	Taxus media 'Everlow'	Everlow Dense Yew	24" wide	2-1
ERENNIALS						
sorted	125	1 Gal.	Assorted Perennials (to be chosen)	Perennial Flowers	Hardy, Disease Resistant	
						10-Arme
						2-
						Juck
<u>SITE</u> DI	STANCE	TRIANG	LES:			
		·				5-Rha
\land			\mathbf{i}			
						4-Juch
		-			ER RUN-OFF AND	2-
		I LANDS	CAPE CODE	VOLUME C	UNIKUL	
TABLE 3.	1.1					
BUFFER Z	ZONE (1	NORTH A	ND EAST)			
			, ,			
		TRIPS; P PLANTING	ER 50 FT.			14-
	ANOPY					
1 OI	RNAMEN	ITAL TRE	E			
20	SHRUBS	5				
NORTH 9	IDF· 5		1UM (256 LF)			3-/
		REQUIRE				2-
11 (CANOPY	PROVIDE	ED			
		NTALS RE	QUIRED			5-
	ROVIDEI SHRUB) S REQUIF	RED			5-Cos
105						
	SHRUB	S FRUM				
103						6-Ju
103 EAST SID	E (410	LF)				
103 EAST SID 17 (E (410 Canopy		ED			

· ____1___1___1__

9 ORNAMENTALS REQUIRED 9 ORNAMENTALS PROVIDED 164 SHRUBS REQUIRED 164 SHRUBS PROVIDED

<u>parkway trees</u> 1 TREE PER 25 LF. 575 LF FRONTAGE (575 LF/25 = 23) 23 TREES REQUIRED; 23 TREES PROVIDED

PARKING LOT GREEN SPACE CALCULATIONS (SECTION 158.20)

21,815 SF AREA OF PARKING LOT $(21,815 \times 0.15 = 3,272 \text{ SF})$ REQUIRED 15% MINIMUM 3,320 SF (15.2%) PROVIDED GREENSPACE AND LANDSCAPE BEDS


LANDSCAPE ORDINANCE 158.14


1 TREE PER DWELLING UNIT

47 UNITS = 47 TREES

47 TREES PROVIDED

© Copyright, 2016 C. M. Lavoie & Associates, Inc. These plans are protected under the copyright laws of the United States and foreign countries, and are to be used only for the construction and/or repair of the Site Improvements as defined in the contract between the Engineer and the Owner. Any use of these plans, including details and specifications, to construct and/or repair additional items not described in these plans, constitutes a violation of the Engineer's copyright of these plans and is prohibited.

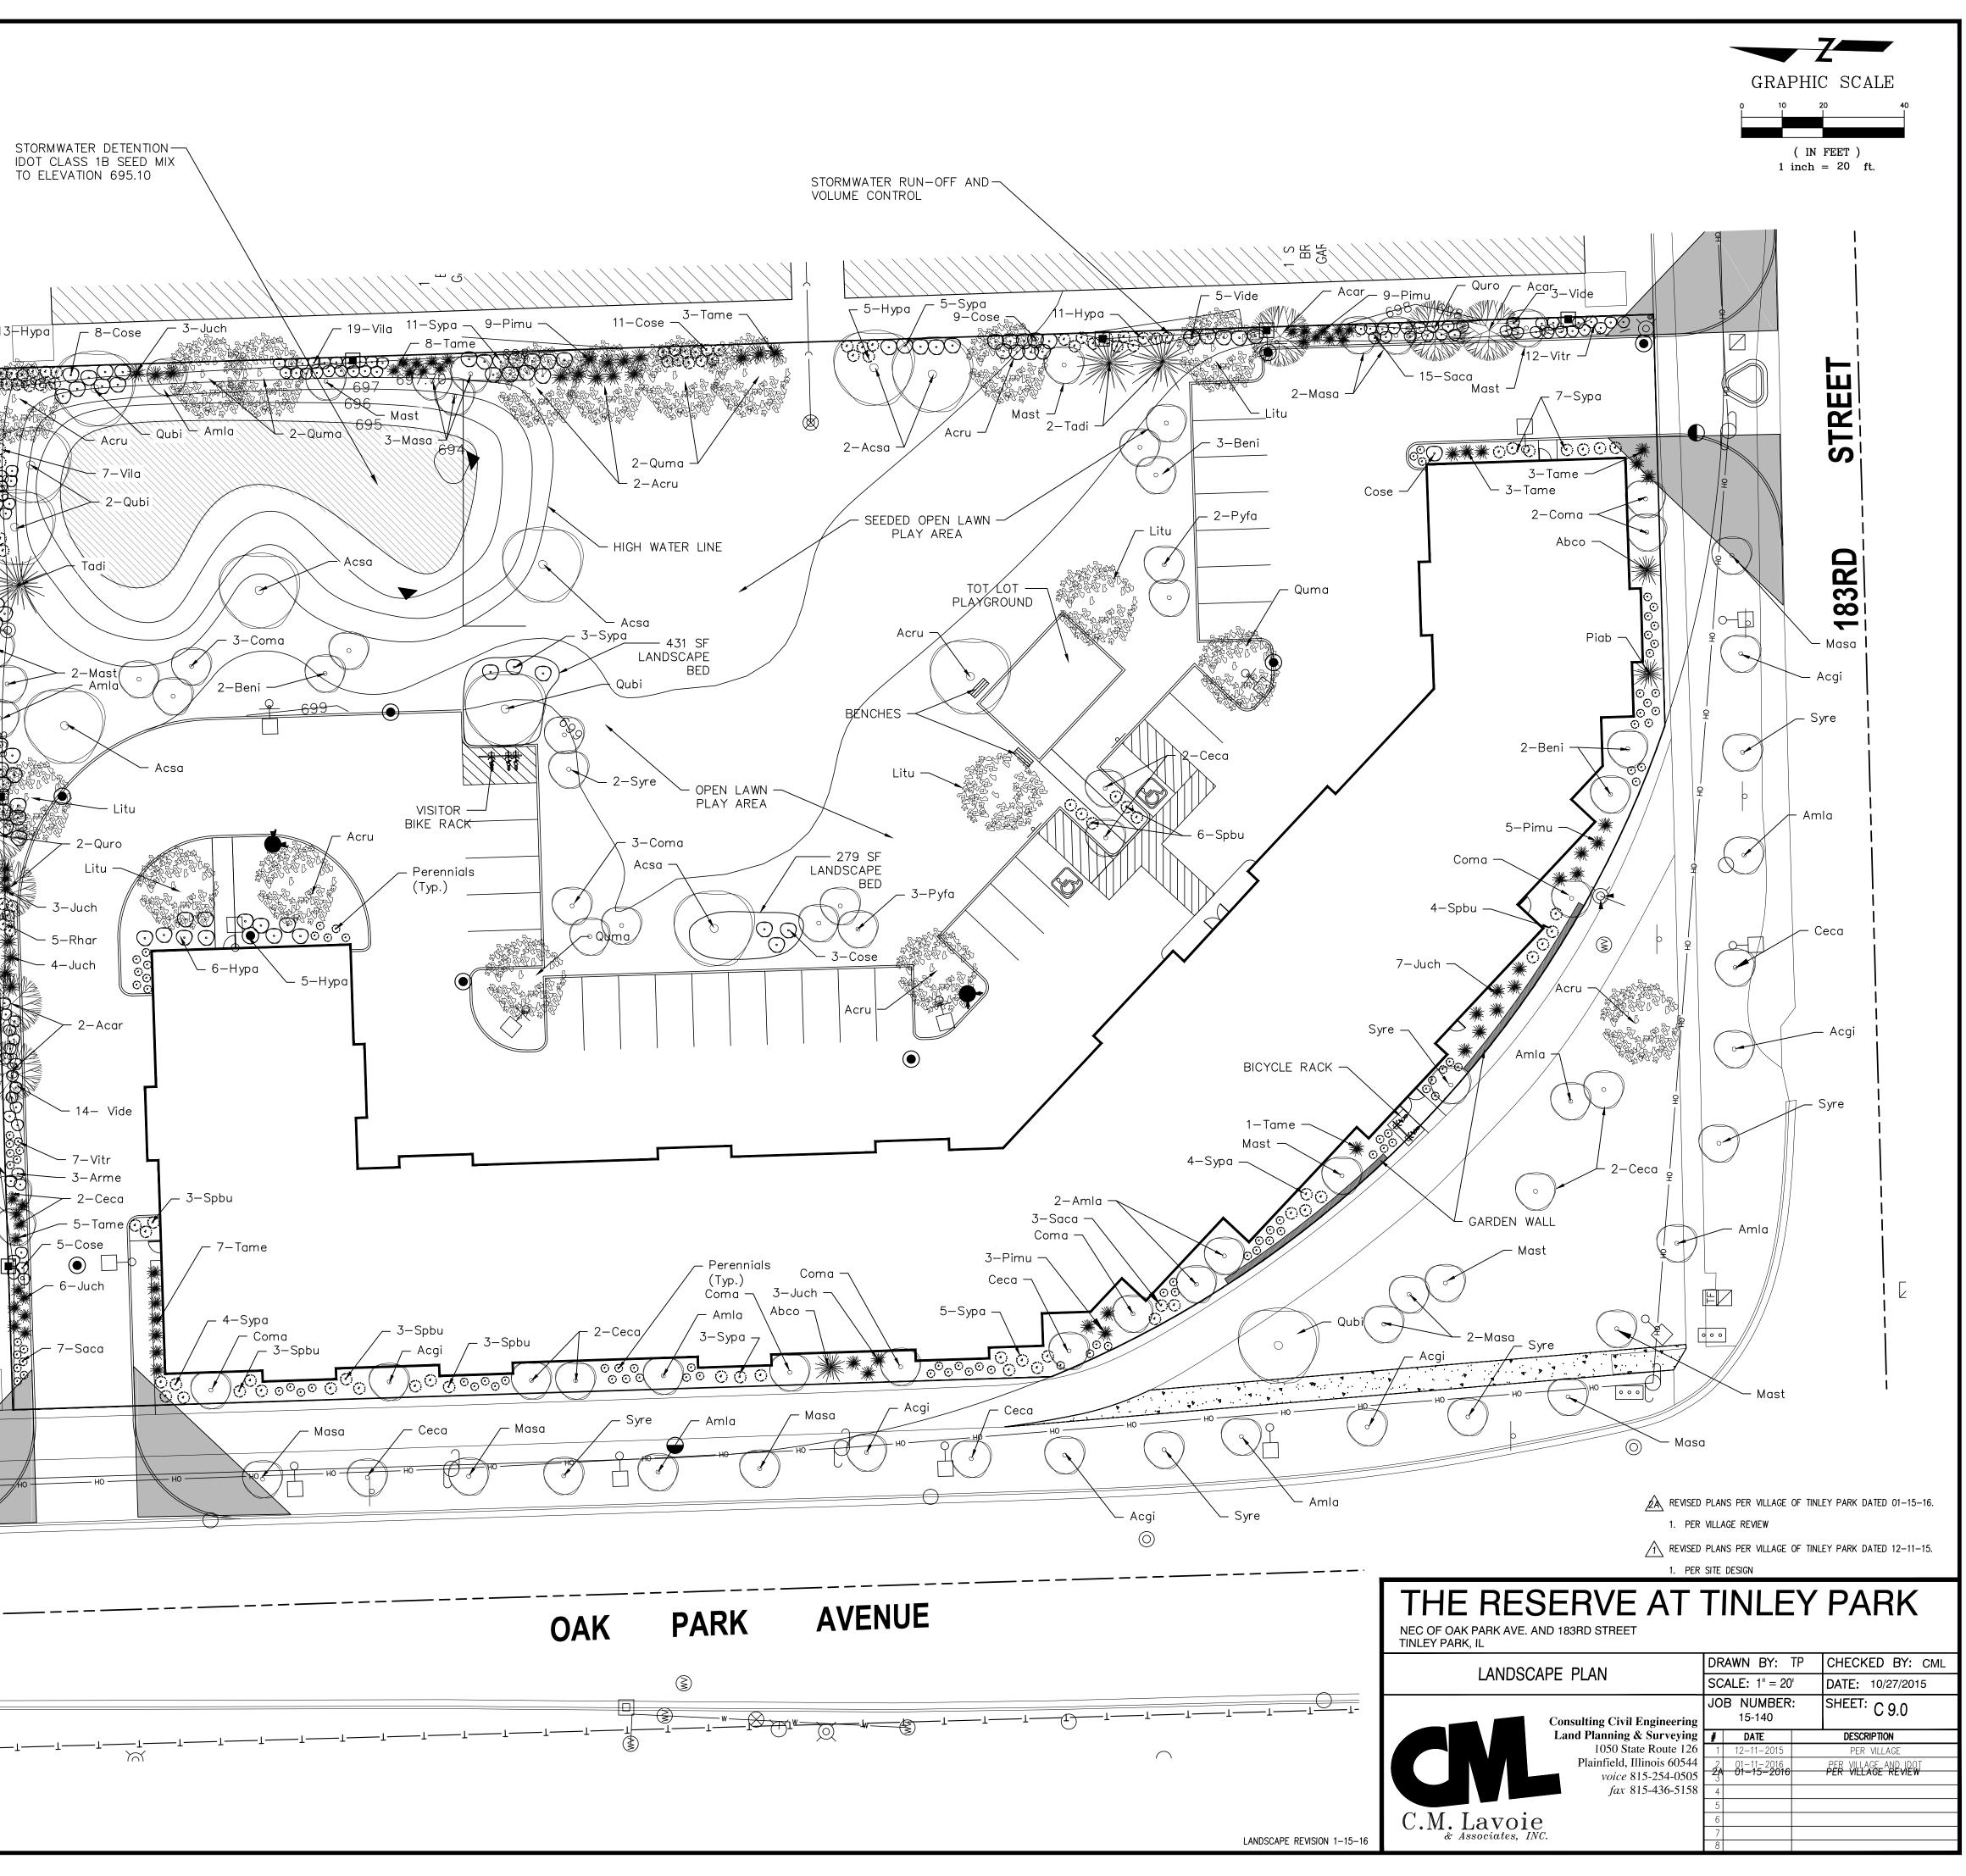

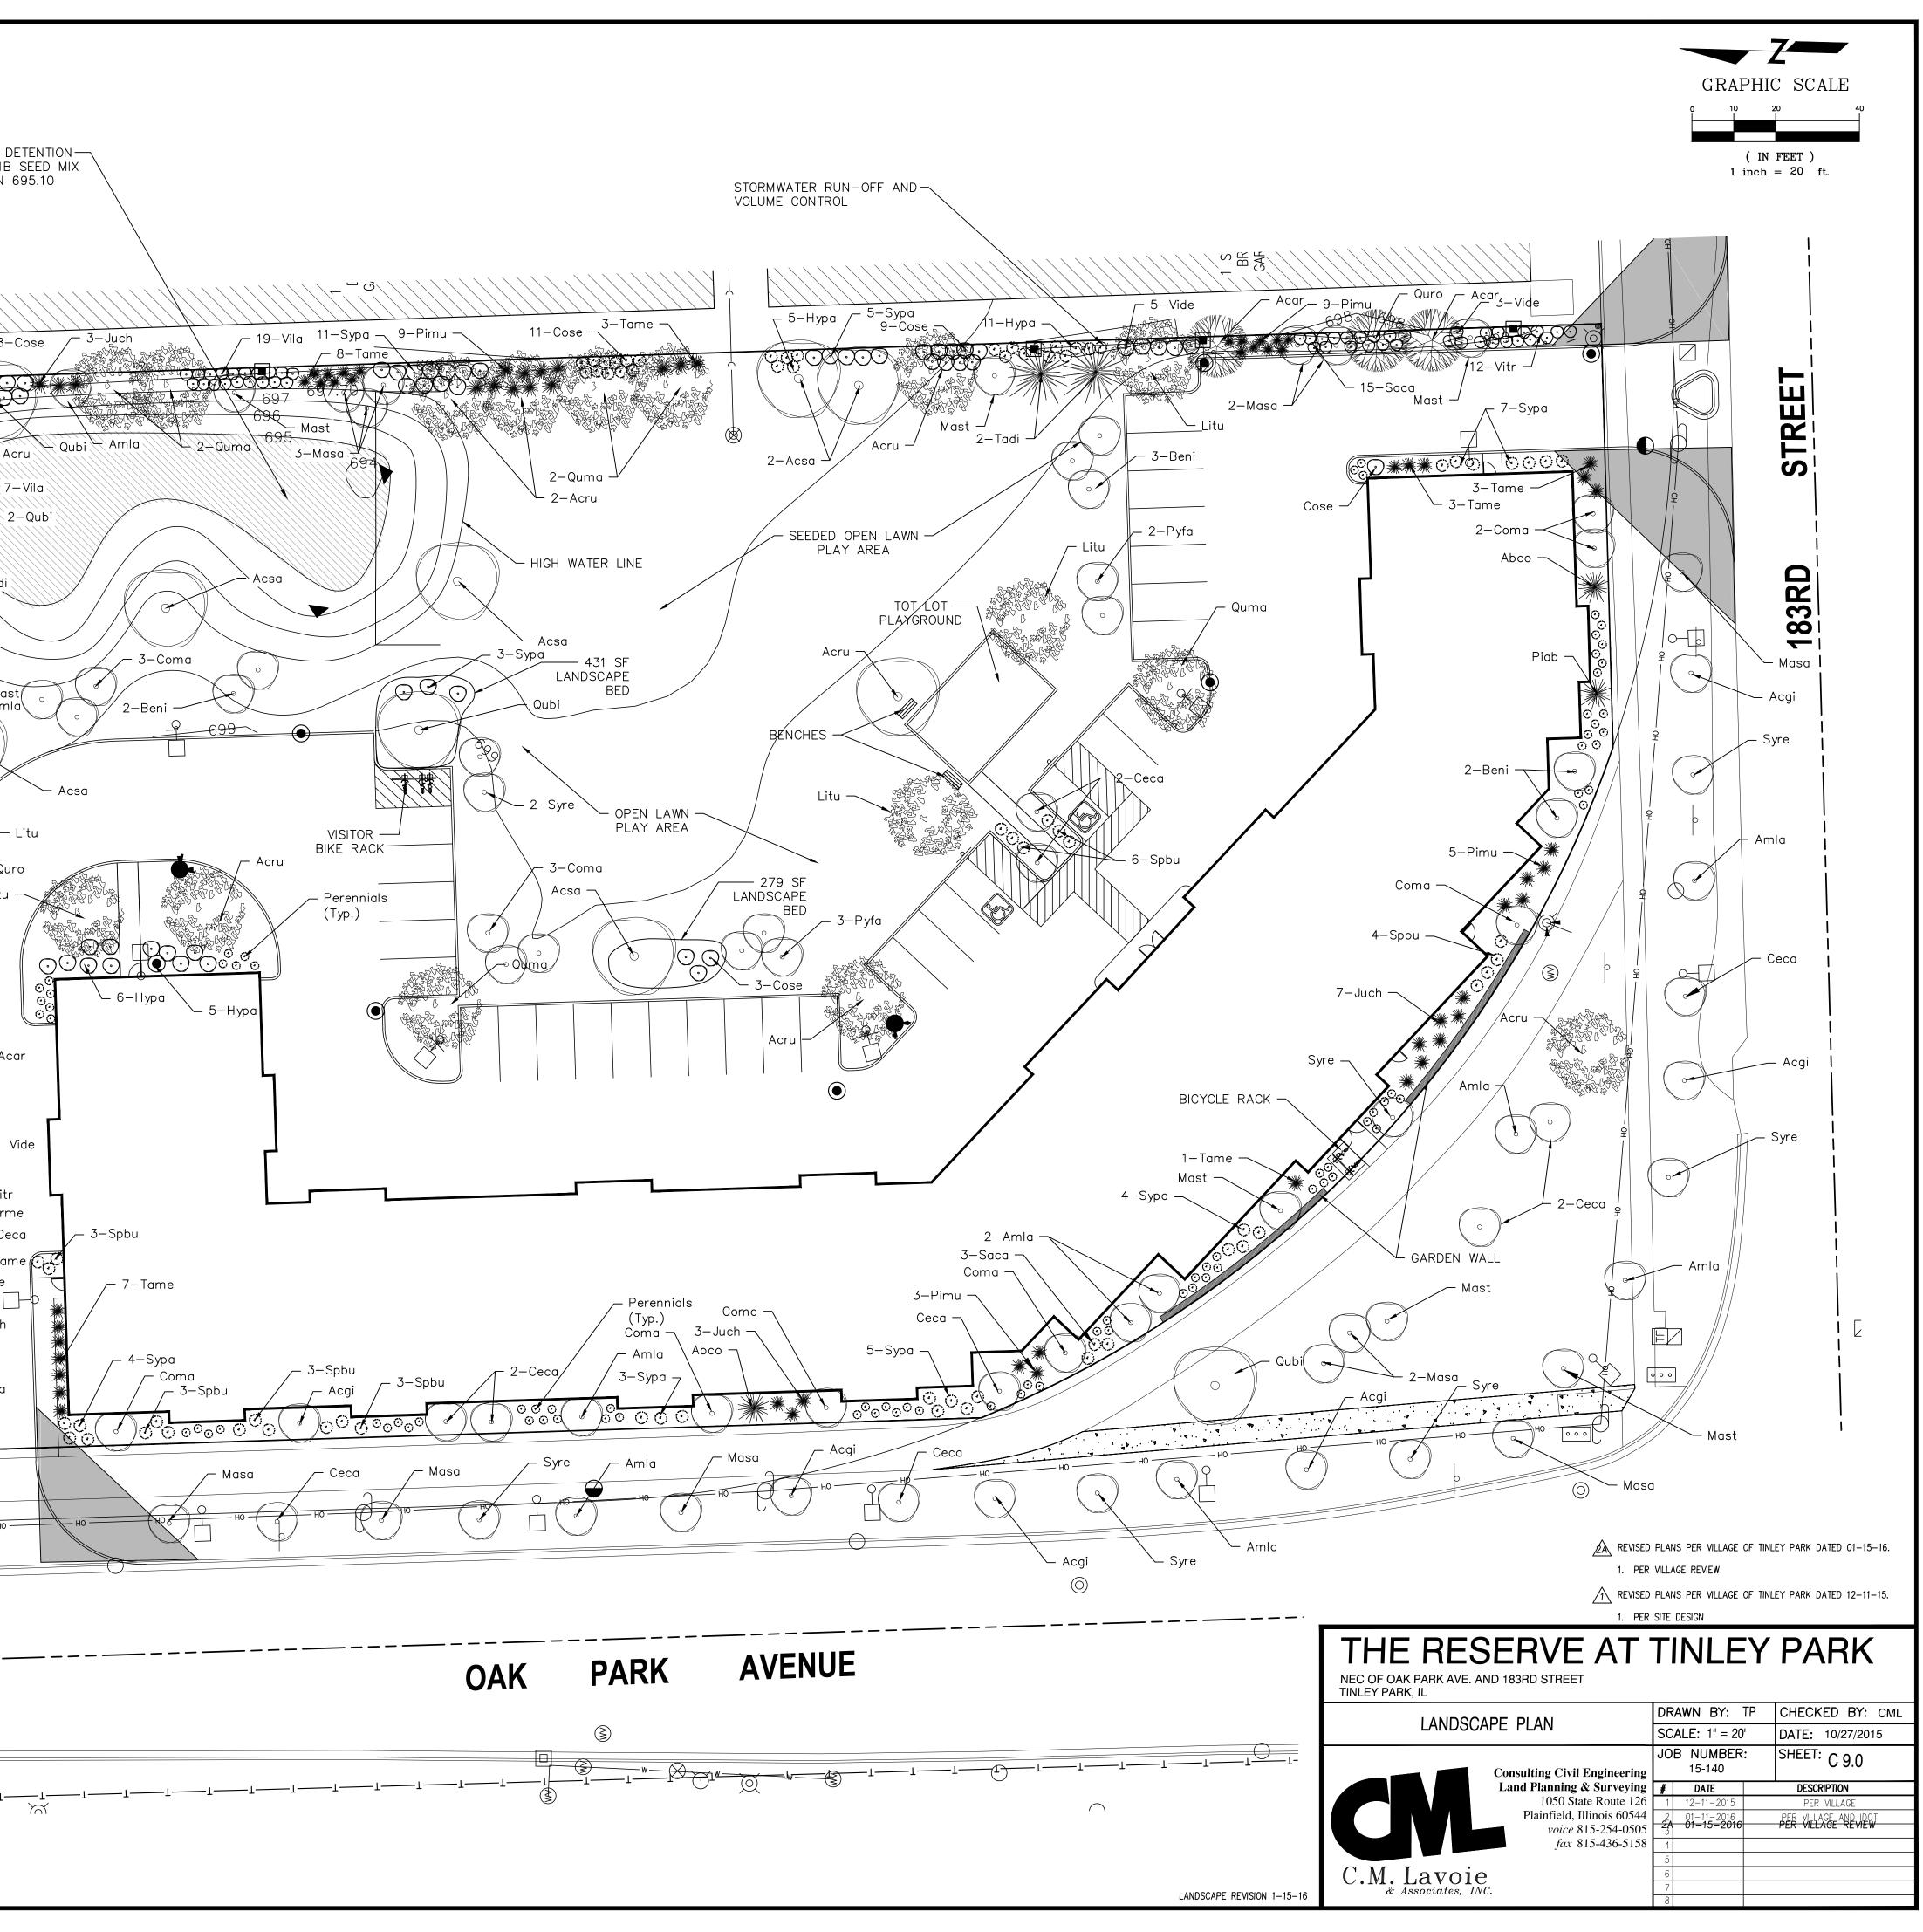




111 North River Road North Aurora, IL 60542 Phone: (800) 323-5664 Fax: (630) 897-0573 sales@belson.com

Model # CBBR-9UR-SS

Dimension Sheet

9 Bike Wave Bike Rack, Stainless Steel, Surface Mount

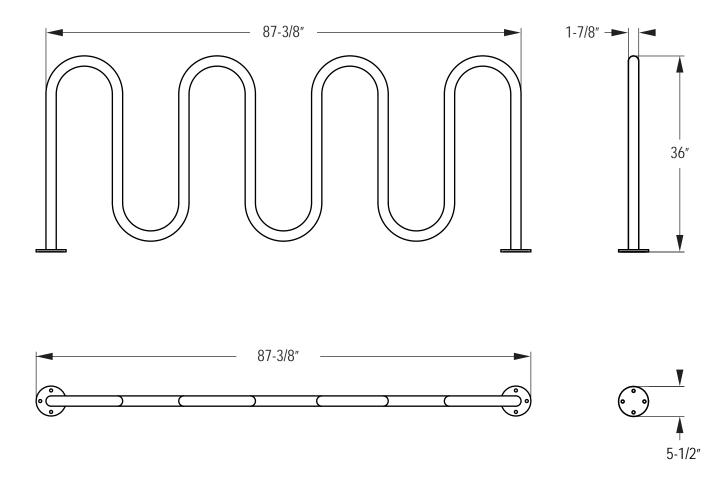



January 5, 2016

Don McNeely The Village of Tinley Park 16250 S. Oak Park Ave. Tinley Park, IL 60477

Subject: The Reserve at Tinley Park Northeast Corner of Oak Park Ave. and 183rd St. Architect's Project No. 15-016

Dear Don:

This letter is to discuss the Tinley Park building code with respect to the construction of the proposed apartment building at the referenced address. It is our understanding that the current building code is under review and a revised code is planned to be approved sometime in late first quarter of 2016. Unfortunately our project is under a strict time schedule in order to obtain specific energy related grants and therefore we are looking at submitting for a permit in January of 2016. Mike Koehl of my office spoke to Dan Riordan on Wednesday December 9th and Dan indicated that if we apply for a building permit in January we will be reviewed under the current code.

Therefore, we have returned to the current code and have put together a description of construction that we propose for The Reserve. We believe that the following construction reflects the intent of the Tinley Park building code. The building would be designed in conformance with Type IB construction and would include the following assemblies and fire ratings:

1. Exterior wall construction: Concrete unit masonry interior wyth, with 3" insulation, then 4" brick on the exterior to form a composite exterior wall. (Insulation is required to comply with the 2015 energy code). UL Des U902 (Alternate) 2hr rating.

K:\Gleason Architects\PROJECTS\15-016 Buckeye Tinley Park\Correspondence\Letter Don McNeely 12-14-15.docx

769 Heartland Drive, Unit A Sugar Grove, Illinois 60554 Phone: 630-466-8740 Fax: 630-466-8760 E-mail: thadgleason@gleasonarchitectspc.com The Village of Tinley Park Don McNeely January 5, 2016 Page 2 of 3

2. Interior demising partitions between units:

Using NFPA 13 fire sprinkler system throughout the building and the following

6" metal studs with 2 layers of 5/8" gypsum board each side with sound insulation in the cavities UL Des U419 2hr fire rating STC 50 non-combustible

3. Corridor partitions:

Using NFPA 13 fire sprinkler system throughout the building and the following

6" metal studs with 2 layers of 5/8" gypsum board each side with sound insulation in the cavities UL Des U419 2hr fire rating STC 50 non-combustible

- 4. Floor system: Concrete pre-cast planks with a 1 ½" topping UL Des J966 2hr fire rating
- Roof system: EPDM roofing on sloped insulation (to meet energy code) on steel deck on steel bar joists with suspended 5/8" gypsum board ceiling UL Des P508 1hr fire rating.
- Stair Enclosure:
 6" CMU masonry with metal furring and 5/8" gypsum board each side UL Des U906 2hr fire rating.

If you see anything in the above description that you have a concern with please let me know. Otherwise we will be proceeding with our construction documents based upon this basis.

Thank you for your assistance.

K:\Gleason Architects\PROJECTS\15-016 Buckeye Tinley Park\Correspondence\Letter Don McNeely 12-14-15.docx

769 Heartland Drive, Unit A Sugar Grove, Illinois 60554 Phone: 630-466-8740 Fax: 630-466-8760 E-mail: thadgleason@gleasonarchitectspc.com The Village of Tinley Park Don McNeely January 5, 2016 Page 3 of 3

Sincerely, Gleason Architects, P.C.


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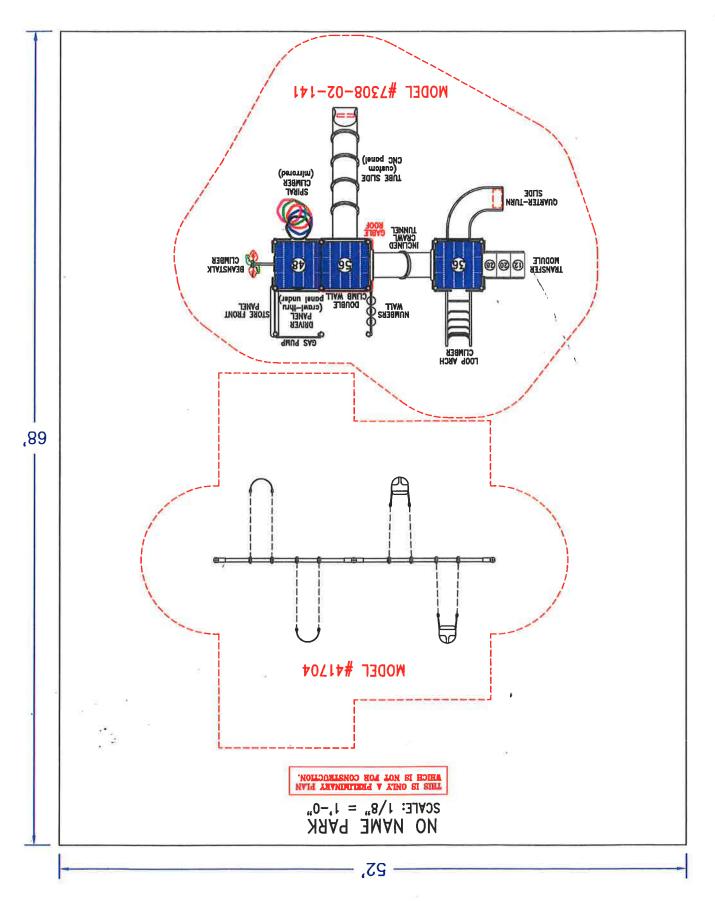
Thad M. Gleason Architect

cc: Dan Riordan, Village of Tinley Park David Petroni, Buckeye Community Hope Foundation Anthony Blum, Tower Contracting

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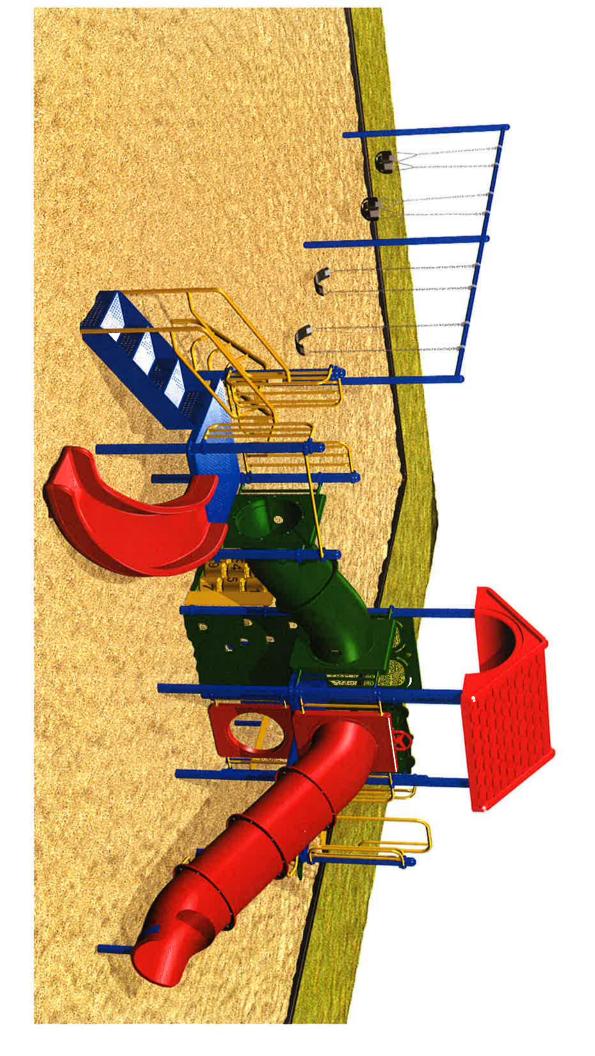
769 Heartland Drive, Unit A Sugar Grove, Illinois 60554 Phone: 630-466-8740 Fax: 630-466-8760 E-mail: thadgleason@gleasonarchitectspc.com







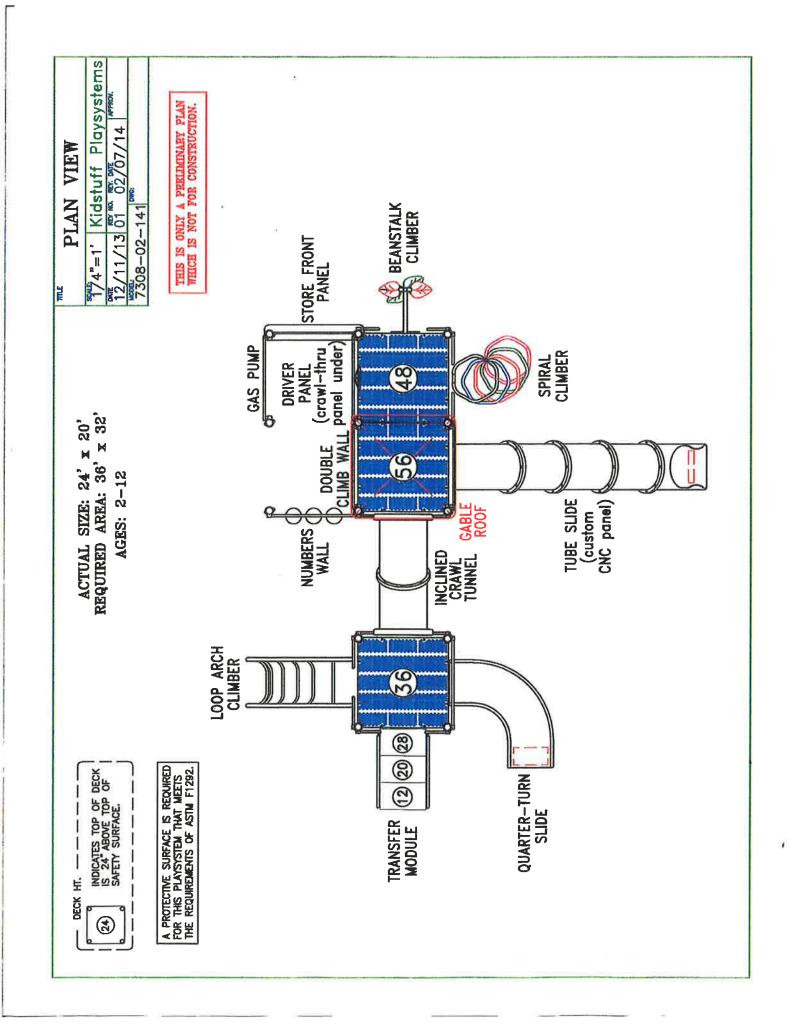








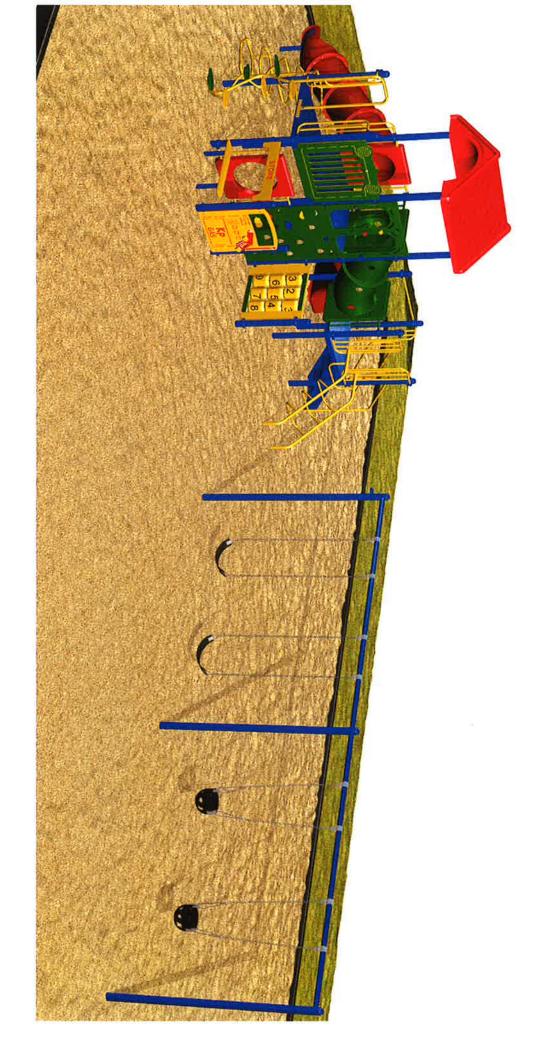

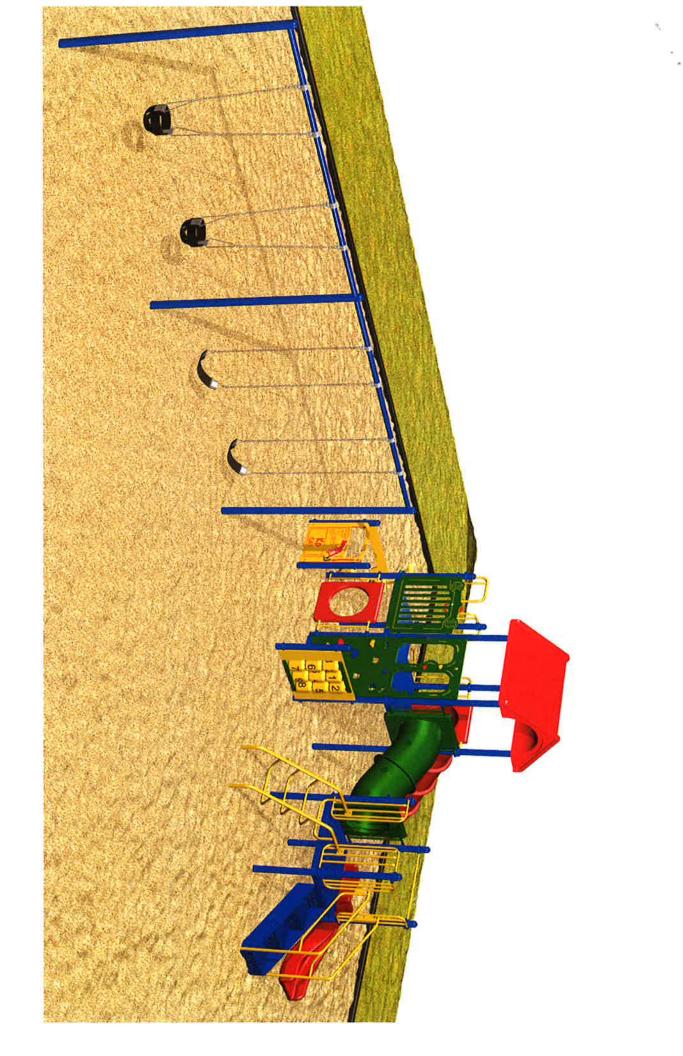

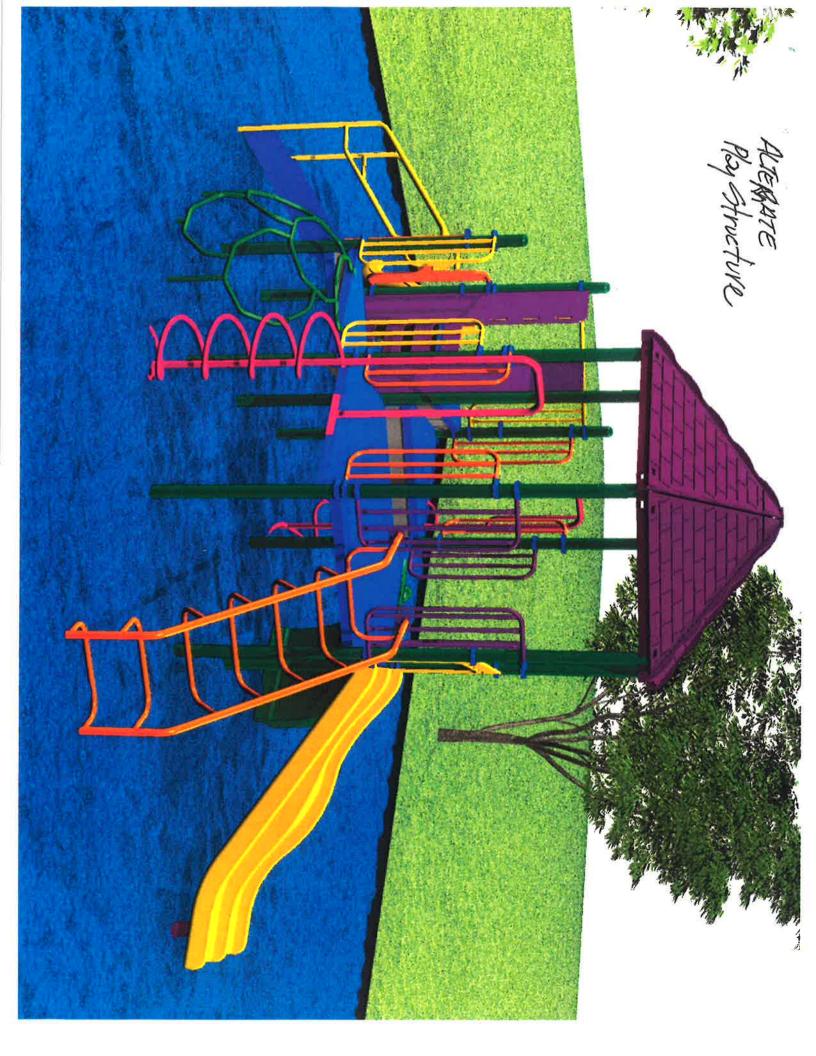

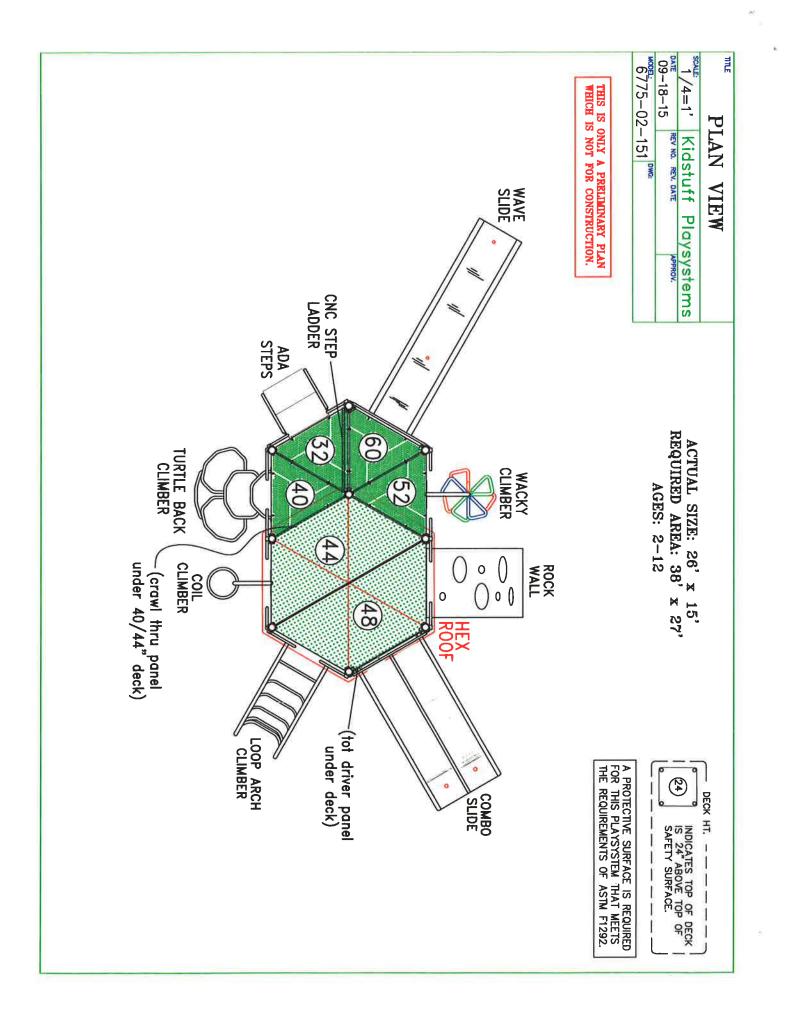

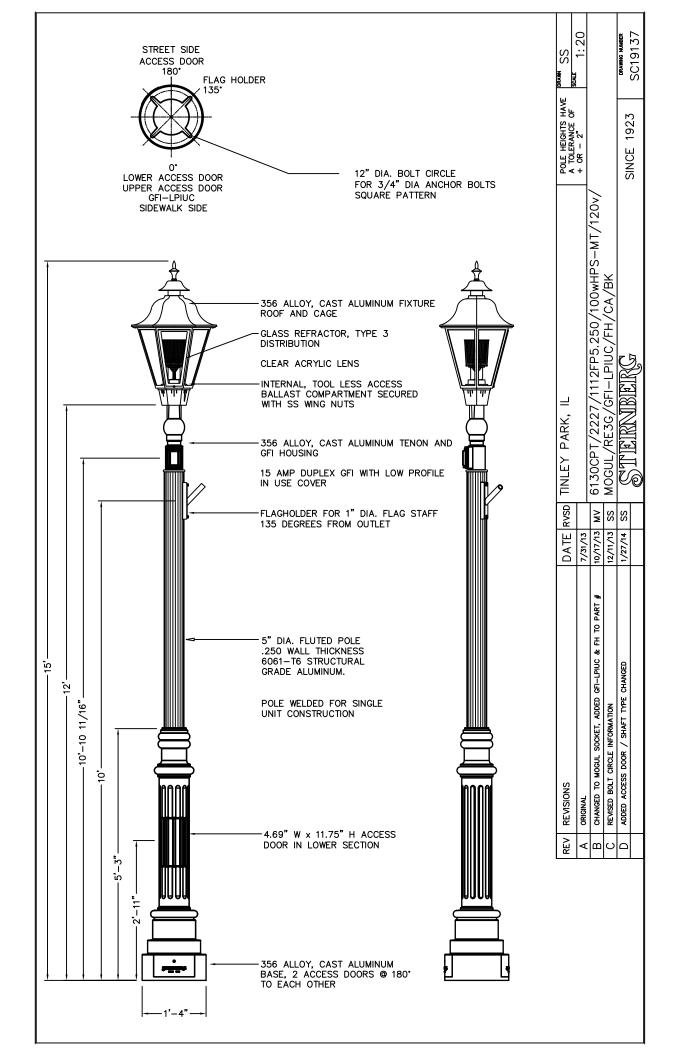

PROJECT TYPE: Pole Mount

LCGR SERIES-LED

S P E C I F I C A T I O N S

LUMINAIRE

One piece high impact polycarbonate prismatic refracting lens provided with durable corrosion resistant cast aluminum fitter, struts, and top. Top is hinged for access. Standard fitter has 3" I.D. opening for tenon. All hardware is stainless steel.

LED POWER ARRAY[™]

Three-dimensional array of individual LED Tubes fastened to a retaining plate. Each LED Tube consists of circuit board populated with a multiple of LED's and is mechanically fastened to a radial aluminum heat sink. An acrylic Lens and end cap protects the LED Tube's internal components.

VERTICAL POWER ARRAY™ WITH REFRACTING

GLOBE: LED Tubes are aligned vertically and arranged radially to produce an even raw light distribution that simulates standard light sources. Used in conjunction with the external refracting lens which provides the optical control.

LED EMITTERS

High Output LED's are driven at 350mA for nominal 1 Watt output each. LED's are available in standard Neutral White (4000K), or optional Cool White (5000K) or Warm White (3000K). Consult Factory for other LED options.


LED DRIVER

UL and CUL recognized Constant Current LED drivers operate on input voltages from 120-277VAC, 50/60hz. Consult Factory for (347-480VAC). Driver is mechanically fastened to a retaining bracket. Main power quick disconnect provided. Driver has a minimum 4KV of internal surge protection, 10KV & 20KV Surge Protector optional. Dimmable and High-Low Driver options available.

FINISH

Polyester powder coat incorporates four step iron phosphate process to pretreat metal surface for maximum adhesion. Top coat is baked at 400°F for maximum hardness and exterior durability.



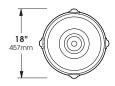












LCGR SERIES - LED

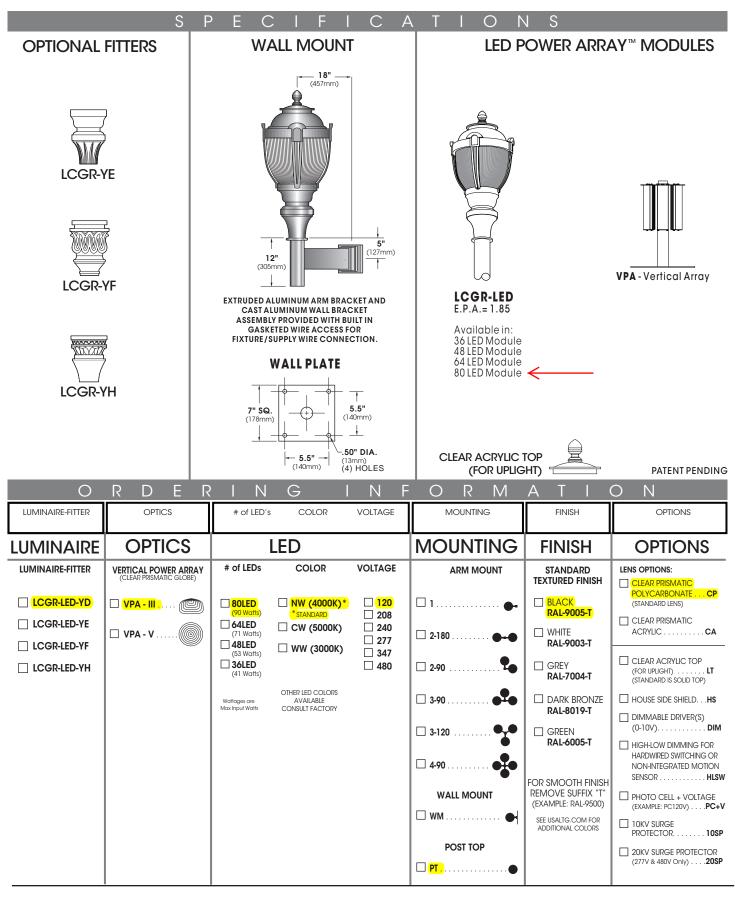

SUN VALLEY

LIGHTING

PROJECT TYPE: Wall Bracket Mount

LCGR SERIES-LED

S P E C I F I C A T I O N S

LUMINAIRE

One piece high impact polycarbonate prismatic refracting lens provided with durable corrosion resistant cast aluminum fitter, struts, and top. Top is hinged for access. Standard fitter has 3" I.D. opening for tenon. All hardware is stainless steel.

LED POWER ARRAY[™]

Three-dimensional array of individual LED Tubes fastened to a retaining plate. Each LED Tube consists of circuit board populated with a multiple of LED's and is mechanically fastened to a radial aluminum heat sink. An acrylic Lens and end cap protects the LED Tube's internal components.

VERTICAL POWER ARRAY™ WITH REFRACTING

GLOBE: LED Tubes are aligned vertically and arranged radially to produce an even raw light distribution that simulates standard light sources. Used in conjunction with the external refracting lens which provides the optical control.

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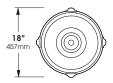
FINISH

Polyester powder coat incorporates four step iron phosphate process to pretreat metal surface for maximum adhesion. Top coat is baked at 400°F for maximum hardness and exterior durability.



* SHOWN WITH **-YD** FITTER

PATENT PENDING












LCGR SERIES - LED

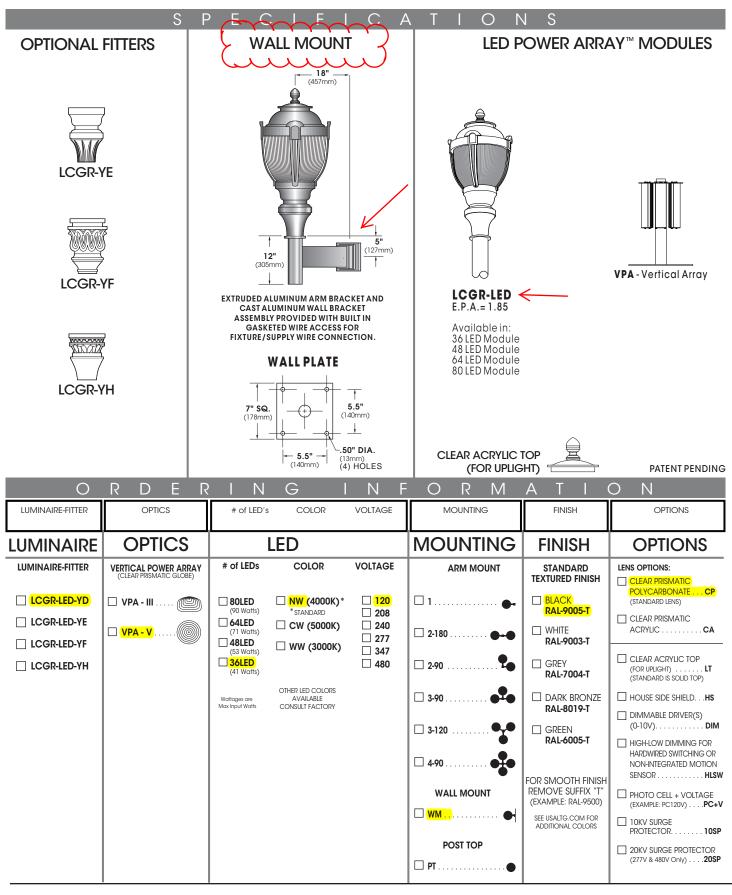

SUN VALLEY

LIGHTING



FEATURES & SPECIFICATIONS

INTENDED USE — The T Series LED surface mount combines digital lighting and control technologies with a high-performance optical system to deliver general ambient lighting for many applications such as schools, offices and hospitals. High-efficacy light engine delivers long life and excellent color, ensuring a superior quality light installation that is highly efficient and sustainable. **Certain airborne contaminants can diminish integrity of acrylic. Click here for Acrylic Environmental Compatibility table for suitable uses.**

Smooth hemmed sides and smooth inward-formed end flanges, for easy handling.

Standard extruded aluminum door frame has superior structural integrity with premium appearance and mitered corners. Door frame is painted after fabrication, standard. Powder-painted rotary cam latches provide easy, secure door closure. Integral T-bar clips are standard. Acrylic shielding material is 100% UV stabilized. **OPTICS** — Standard pattern #19 lens, 0.156" thick with highly transmissive overlay, is standard for superior brightness control. Overlay is 0.040" thick. Other lenses are available.

ELECTRICAL — Long-life LEDs, coupled with high-efficiency drivers, provide superior quantity and quality of illumination for extended service life. 90% LED lumen maintenance at 60,000 hours (L90/60,000).

nLight[®] embedded controls make each luminaire addressable – allowing it to digitally communicate with other nLight enabled controls such as dimmers, switches, occupancy sensors and photocontrols. Simply connect all the nLight enabled control devices and the luminaires using standard Cat-5 cabling. Unique plug-and-play convenience as devices and luminaires automatically discover each other and self-commission.

Lumen Management: Unique lumen management system (option N80) provides onboard intelligence that actively manages the LED light source so that constant lumen output is maintained over the system life, preventing the energy waste created by the traditional practice of over-lighting.

Step-level dimming option allows system to be switched to 50% power for compliance with common energy codes while maintaining fixture appearance.

eldoLED driver options deliver choice of dimming range, and choices for control, while assuring flicker-free, low-current inrush, 89% efficiency and low EMI.

Driver disconnect provided where required to comply with US and Canadian codes.

INSTALLATION — Surface mount. Drivers and internal components are accessible from floor. LED boards include plug-in connectors for easy replacement or servicing. Suitable for damp location.

LISTINGS — CSA certified to US and Canadian standards. DesignLights Consortium[®] (DLC) qualified product. Not all versions of this product may be DLC qualified. Please check the DLC Qualified Products List at <u>www.designlights.org/QPL</u> to confirm which versions are qualified.



WARRANTY — 5-year limited warranty. Complete warranty terms located at www.acuitybrands.com/CustomerResources/Terms_and_conditions.aspx

Note: Actual performance may differ as a result of end-user environment and application. All values are design or typical values, measured under laboratory conditions at 25 °C. Specifications subject to change without notice.

ORDERING INFORMATION

2TLX2

 FORMATION
 Lead times will vary depending on options selected. Consult with your sales representative.
 Example: 2TLX2 33L RW A19 EZ1 LP835 N80

 Lumens¹
 Door
 Lens
 Voltage

Color temperature	Control	Options
LP830 3000 K LP835 3500 K (LP840) 4000 K LP850 5000 K	(blank) No controls N80 nLight with 80% (L80) lumen management N80EMG nLight with 80% (L80) lumen management for use with generator supply EM power N100 nLight without lumen management N100EMG nLight without lumen management N100EMG nLight without lumen management	EL7L 700 nominal lumen battery pack EL14L 1400 nominal lumen battery pack

Notes

1 Approximate lumen output.

2 Not available with EL7L or EL14L battery packs or SLD driver.

3 Not available with N80, N80EMG, N100, or N100EMG

4 Gateway not included. Requires on-site commissioning.

Visit www.lightingcontrols.com/XPointWireless for more information.

Number


Catalog

Notes

Туре


	Performance Data							
Lumen	Package	Lumens	Input Watts	LPW				
20L	LP830	2,034.7	18	113.0				
20L	LP835	2,078.3	18	115.5				
20L	LP840	2,092.9	18	116.3				
20L	LP850	2,165.6	18	120.3				
33L	LP830	3,246.3	29	111.9				
33L	LP835	3,317.0	29	114.4				
33L	LP840	3,339.8	29	115.2				
33L	LP850	3,458.3	29	119.3				
40L	LP830	3,811.6	35	108.9				
40L	LP835	3,892.7	35	111.2				
40L	LP840	3,921.8	35	112.1				
40L	LP850	4,058.9	35	116.0				

MOUNTING DATA

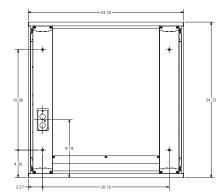


PHOTOMETRICS

2TL2 33L FW A12 EZ1 LP840, 3339.8 delivered lumens, test no. LTL26923P18, tested in accordance to IESNA LM-79.

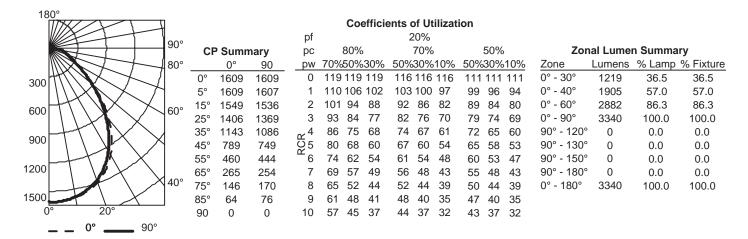

Constant Lumen Management

Enabled by the embedded nLight control, the TLX actively tracks its run-time and manages its light source such that constant lumen output is maintained over the system life. Referred to as lumen management, this feature eliminates the energy waste created by the traditional practice of over-lighting.

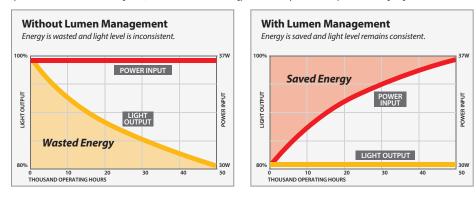

🔶 LITHONIA LIGHTING

2TLX2-2X2

An **Acuity**Brands Company



VILLAGE OF TINLEY PARK 16250 OAK PARK AVENUE

TINLEY PARK, IL 60477

VENDOR: 015994 STERNBERG LIGHTING, INC. 36162 TREASURY CENTER CHICAGO, IL 60694

FOB Point: Terms: A/P Net 30 Days

Req. Del. Date:

Special Inst:

DATE 7/3/2014 PO NUMBER ______

TOTAL

14,420.00

SHIP TO: VILLAGE OF TINLEY PARK PUBLIC WORKS GARAGE 7980 W. 183RD STREET TINLEY PARK, IL 60477

Req. No.:


Dept.: PUBLIC WORKS Contact: GABRIEL, GERRY per J Dickey Confirming? No

Quantity	Unit	Description	Unit Price	Ext. Price
4.00		2227/1112TFPS/GFI-LPIUC/FH/BK	1,958.0000	7,832.00
		Pole only, 2 access doors @ 180 degrees		
		of each other and additional upper		
		access door.		
6.00		6130CPT/100WHPS-MT/120V/MOG/RE3/CA/BK	1,098.0000	6,588.00
		Post top fixture head only		
			SUBTOTAL	
			SUBIUIAL	14,420.00
l to: VILLA	GE OI	F TINLEY PARK	TAX	<u>14.420.00</u> 0.00


TINLEY PARK, IL 60477

Account Number	Amount	Account Number	Amount

Ben St Ketterhaune

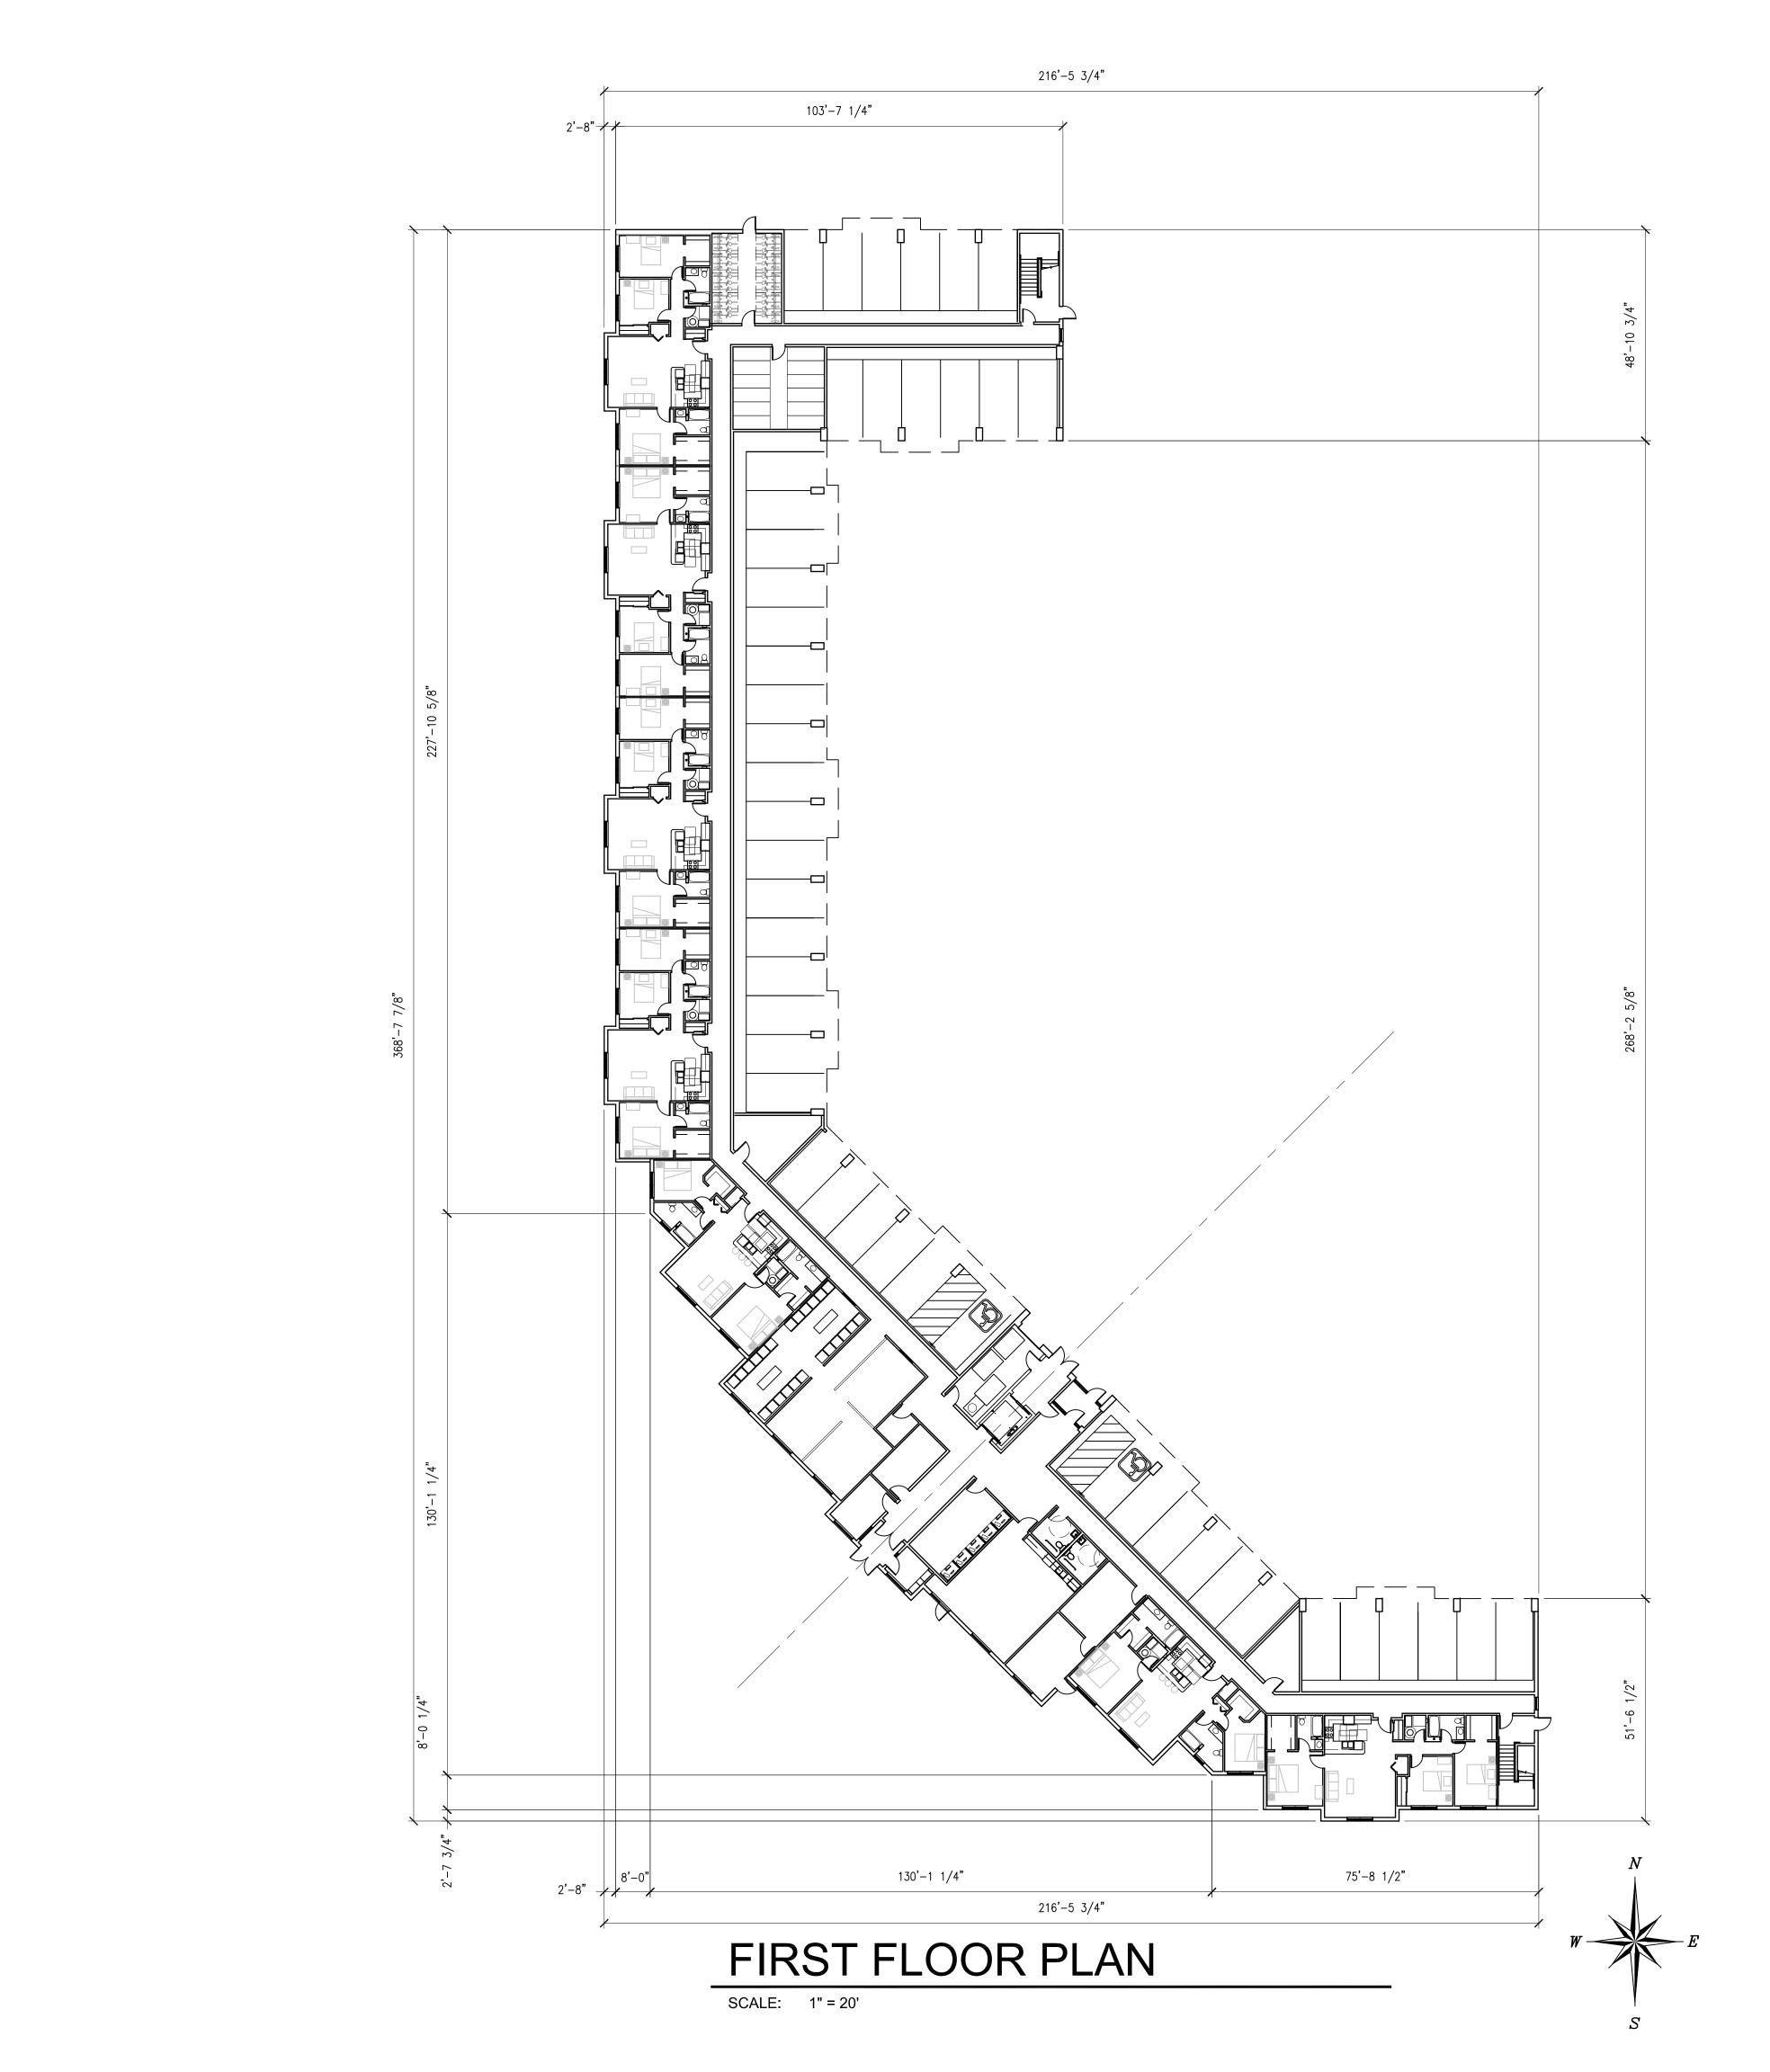


- 1. ALL INTERIOR DIMENSIONS ARE TO FACE OF FINISH UNLESS NOTED OTHERWISE
- 2. ALL EXTERIOR DIMENSIONS ARE TO FACE OF FOUNDATION WALL UNLESS NOTED OTHERWISE
- 3. ALL STEEL COLUMNS SHALL RECEIVE SPRAY APPLIED FIREPROOFING UL # X752 1 HOUR RATING
- 4. THE GURNEE SIZED ELEVATOR (INDICATED ON THE PLAN) SHALL BE IDENTIFIED BY THE INTERNATION SYMBOL FOR EMERGENCY MEDICAL SERVICES (STAR OF LIFE). THE SYMBOL SHALL BE NOT LESS THAN THREE INCHES (3") HIGH AND SHALL BE PLACED ON BOTH SIDES OF THE HOIST WAY DOOR FRAME
- 5. THE WATER MAIN SERVING THE FIRE SPRINKLER SYSTEM TO BE FLUSHED AT A RATE APPRPRIATE TO ITS SIZE, PRIOR TO CONNECTION TO THE SYSTEM. NOTIFY THE LOCAL AUTHORITY TWENTY-FOUR HOURS (24) IN ADVANCE OF THE FLUSHING TO WITNESS.
- 6. PROVIDE AN APPROVED PICTORAL SIGN OF A STANDARDIZED DESIGN SHALL BE POSTED ADJACENT TO EACH ELEVATOR CALL STATION ON ALL FLOORS INSTRUCTING OCCUPANTS TO USE THE EXIT STAIRWAYS AND NOT TO USE THE ELEVATOR IN CASE OF FIRE. THE SIGN SHALL READ: "IN FIRE EMERGENCY, DO NOT USE ELEVATOR, USE EXIT STAIRS."
- PROVIDE A KEY BOX IF REQUIRED BY THE LOCAL AUTHORITY. VERIFY WITH THE AHJ THE DEVICE REQUIREMENTS AND LOCATION
- ROOMS CONTAINING CONTROLS FOR AIR-CONDITIONING SYSTEMS, SPRINKLER RISERS, AND VALVES, OR OTHER FIRE DETECTION, SUPPRESSION, OR CONTROL ELEMENTS SHALL BE IDENTIFIED WITH SIGNAGE OF DURABLE MATERIALS, PERMANENTLY INSTALLED, AND READILY VISIBLE.
- PROVIDE SIGNAGE ON DOORS OF ALL ELECTRICAL ROOMS CONTAINING CONTROL PANELS STATING: "ELECTRICAL ROOM". REFER TO SHEET A10.4

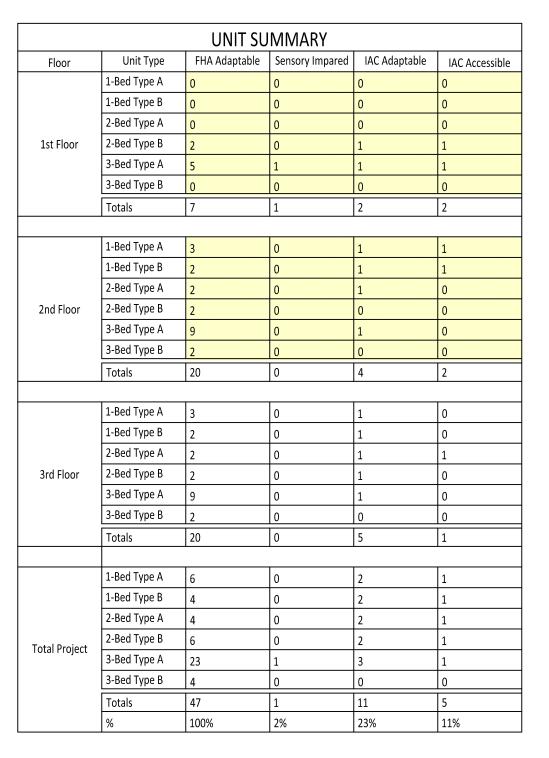




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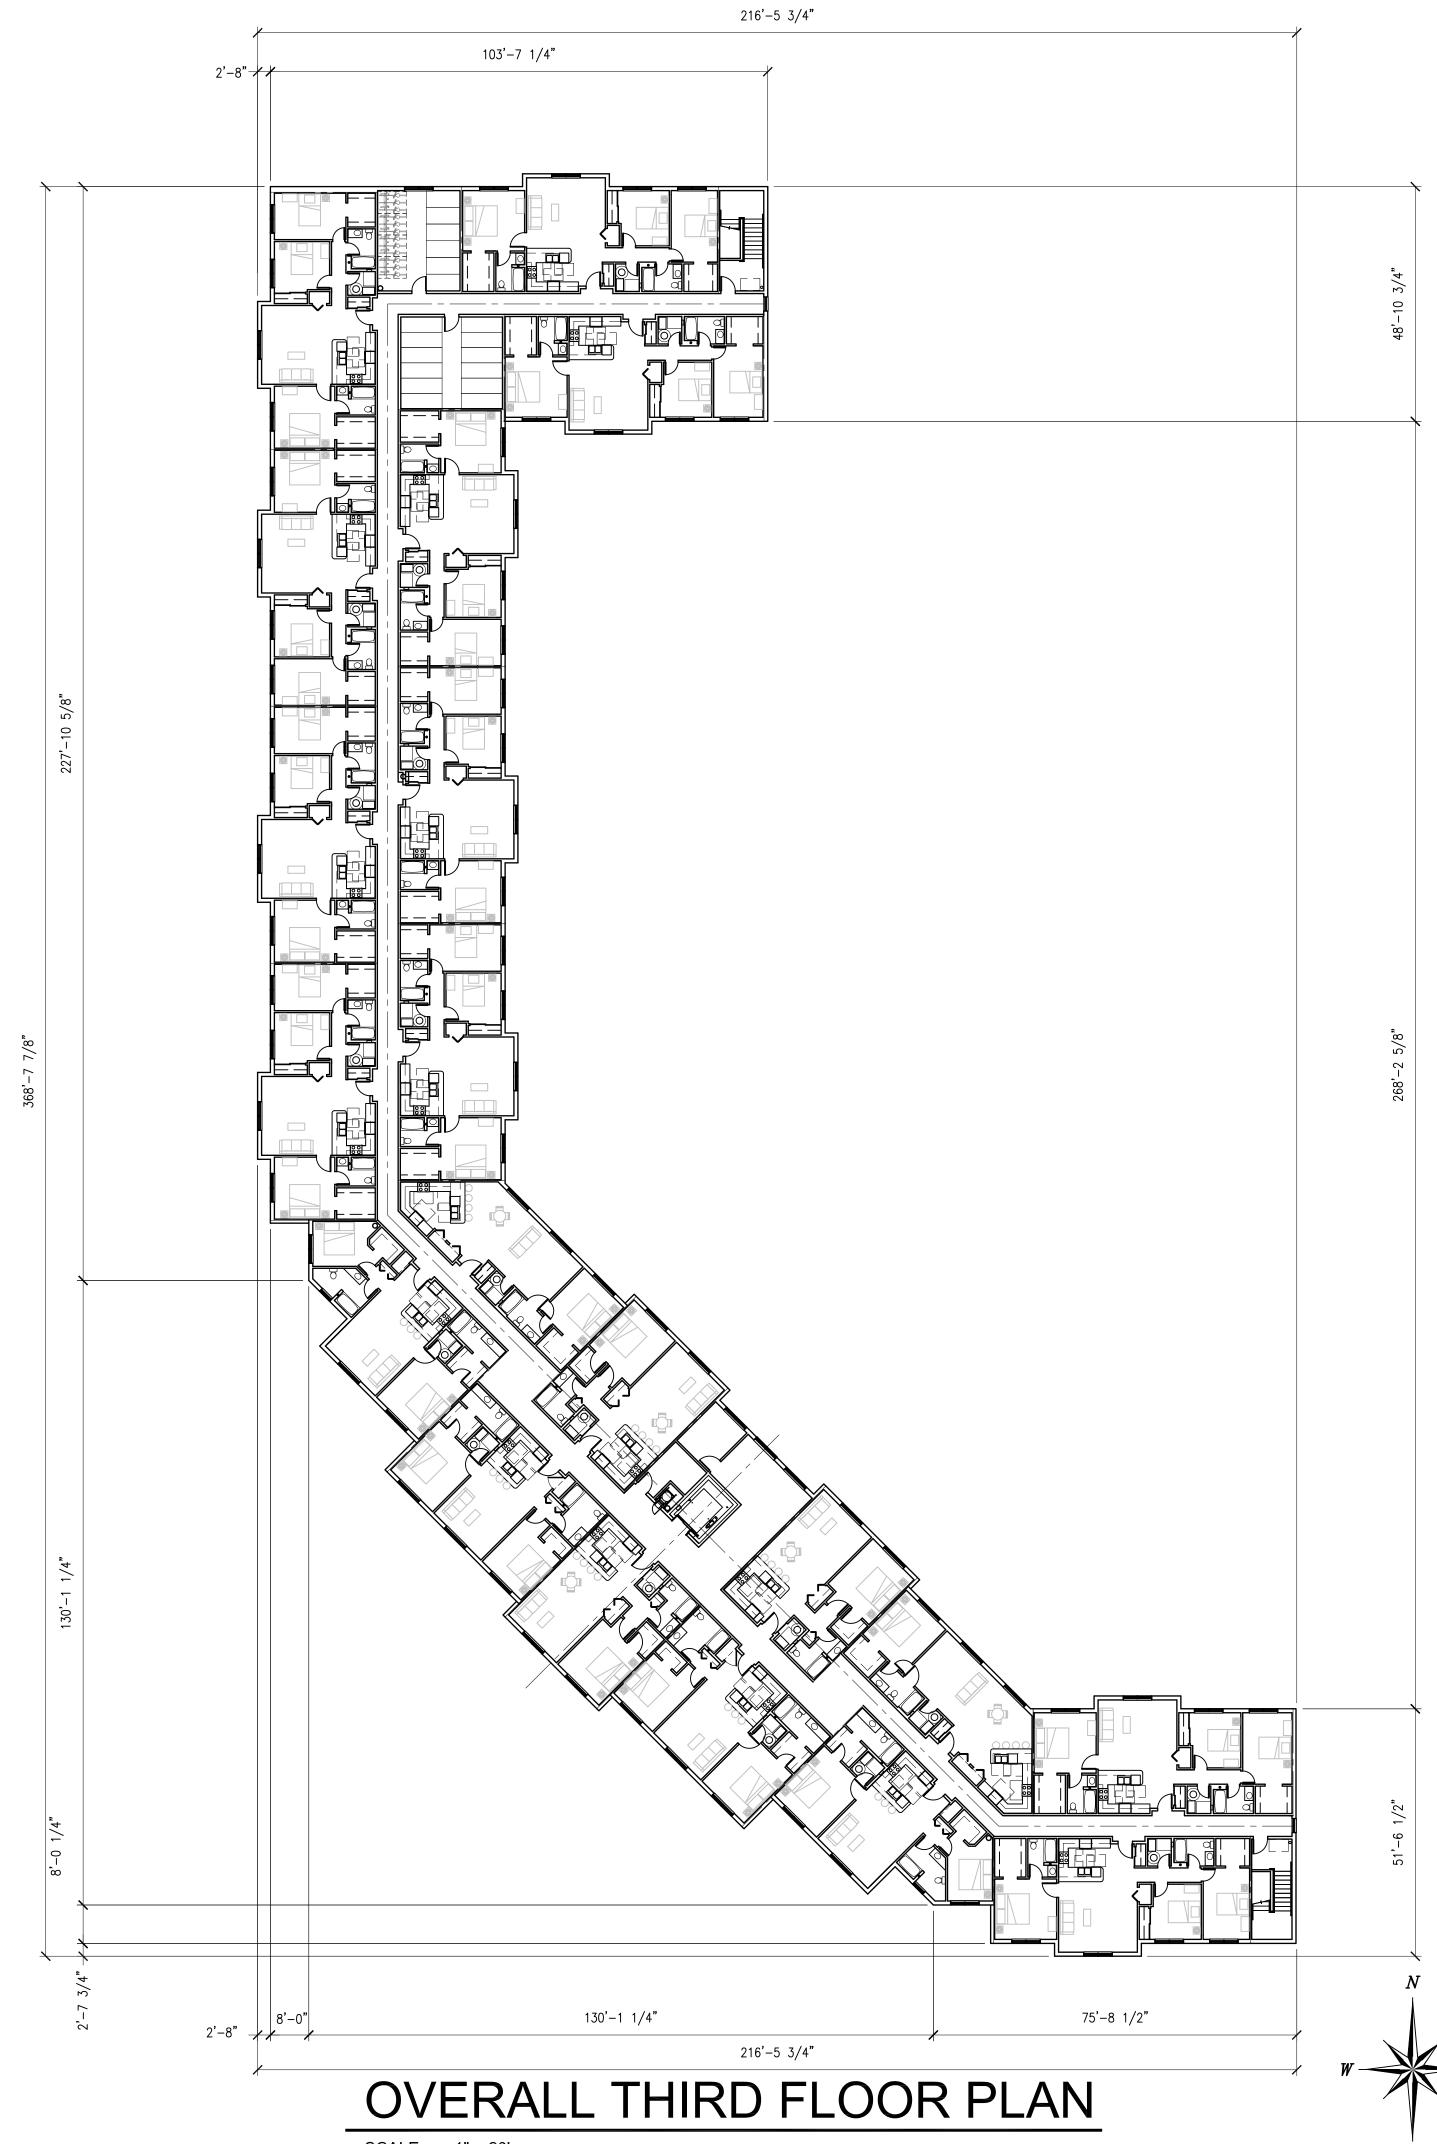
- 1. ALL INTERIOR DIMENSIONS ARE TO FACE OF FINISH UNLESS NOTED OTHERWISE
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- 5. THE WATER MAIN SERVING THE FIRE SPRINKLER SYSTEM TO BE FLUSHED AT A RATE APPRPRIATE TO ITS SIZE, PRIOR TO CONNECTION TO THE SYSTEM. NOTIFY THE LOCAL AUTHORITY TWENTY-FOUR HOURS (24) IN ADVANCE OF THE FLUSHING TO WITNESS.
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- PROVIDE A KEY BOX IF REQUIRED BY THE LOCAL AUTHORITY. VERIFY WITH THE AHJ THE DEVICE REQUIREMENTS AND LOCATION
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- PROVIDE SIGNAGE ON DOORS OF ALL ELECTRICAL ROOMS CONTAINING CONTROL PANELS STATING: "ELECTRICAL ROOM". REFER TO SHEET A10.4



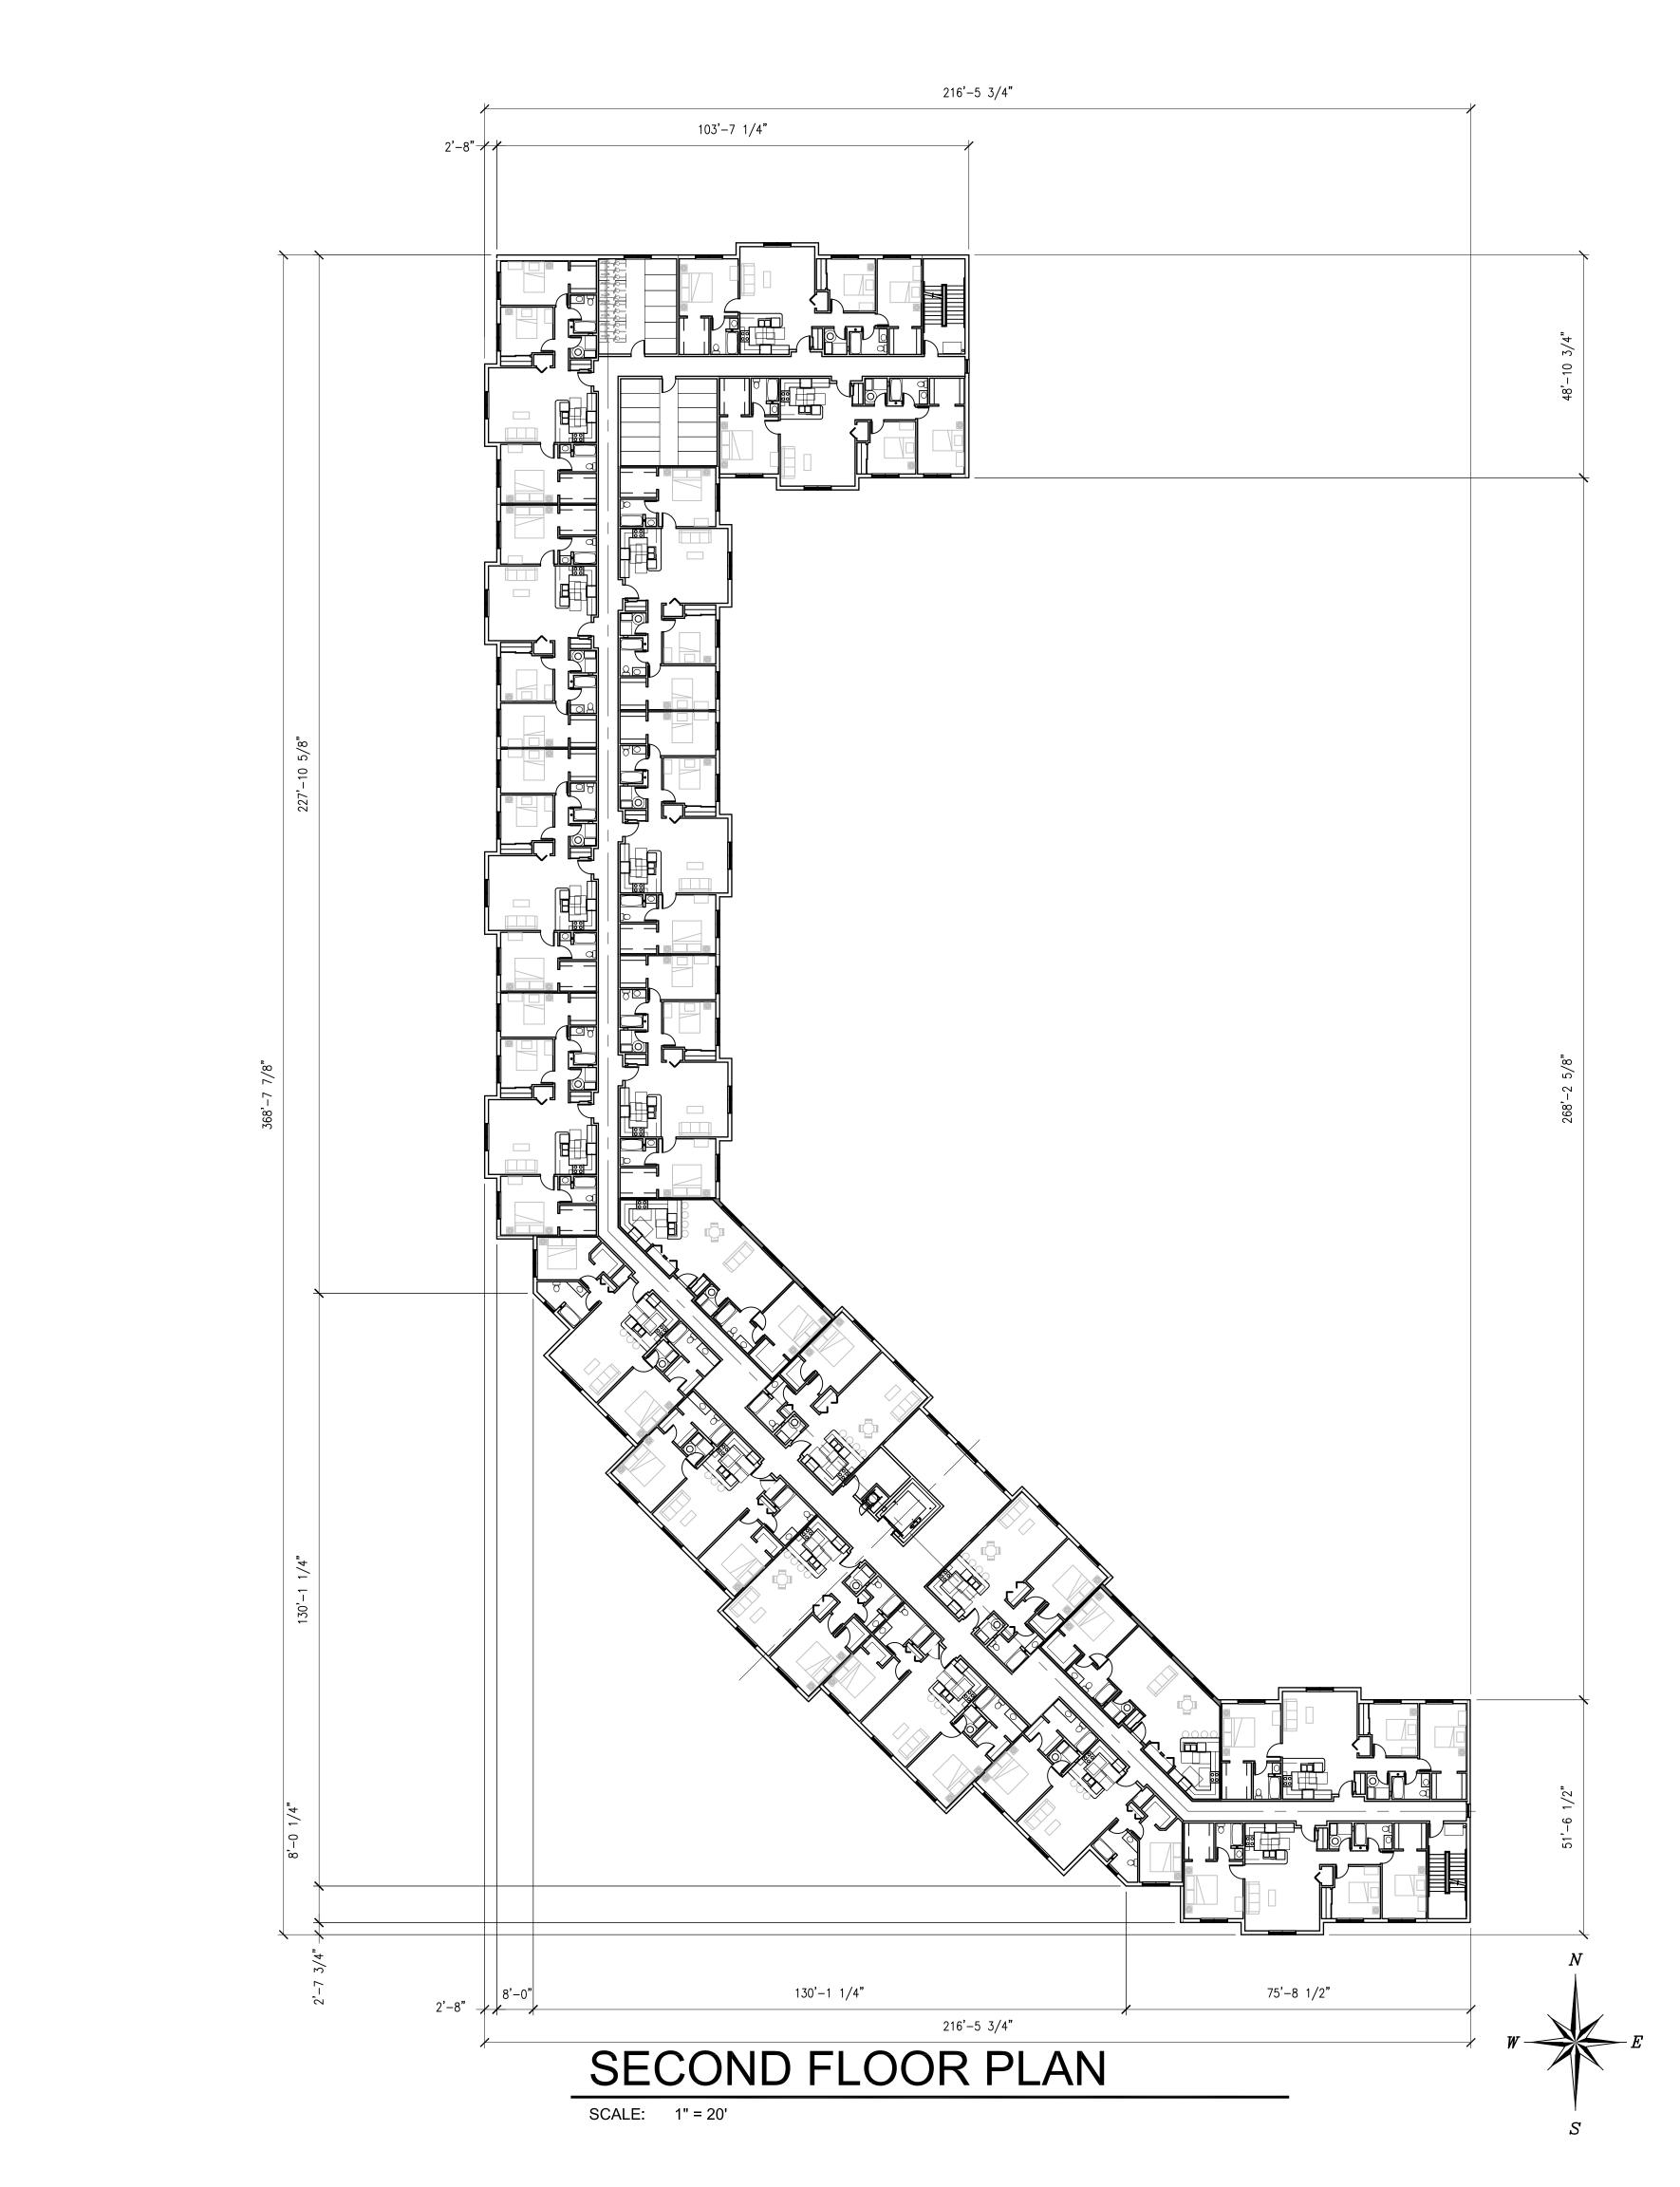



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PROJECT: THE RESERVE AT TINLEY PARK NORTHEAST CORNER OF OAK PARK AVENUE AND 183RD ST TINLEY PARK, IL	CLIENT: BUCKEYE COMMUNITY HOPE FOUNDATION 3021 EAST DUBLIN-GRANVILLE RD COLUMBUS OH 43231
JOB NO. DATE FILE PLOT SCALE OWNER APPI	
Signature	Date
-	TITLE SECOND R PLAN
SHEET N	NUMBER

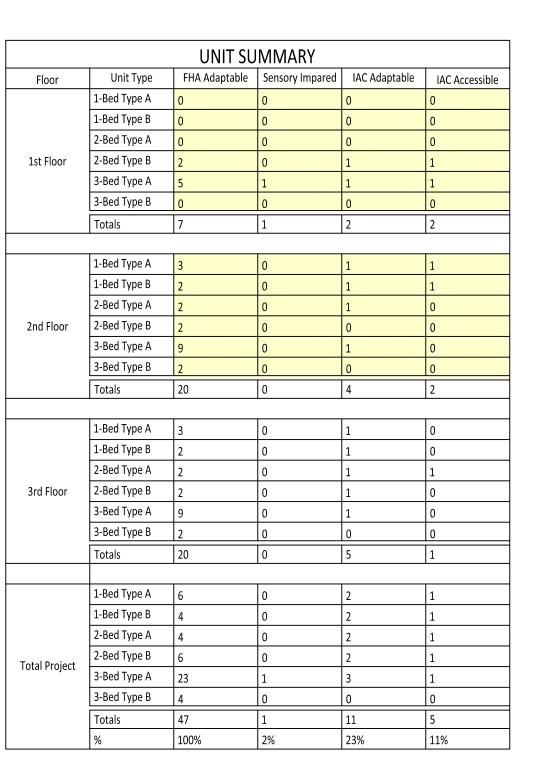


- 1. ALL INTERIOR DIMENSIONS ARE TO FACE OF FINISH UNLESS NOTED OTHERWISE
- ALL EXTERIOR DIMENSIONS ARE TO FACE OF FOUNDATION WALL UNLESS NOTED OTHERWISE 2.
- ALL STEEL COLUMNS SHALL RECEIVE SPRAY APPLIED FIREPROOFING UL # X752 1 HOUR 3. RATING
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- THE WATER MAIN SERVING THE FIRE SPRINKLER SYSTEM TO BE FLUSHED AT A RATE 5. APPRPRIATE TO ITS SIZE, PRIOR TO CONNECTION TO THE SYSTEM. NOTIFY THE LOCAL AUTHORITY TWENTY-FOUR HOURS (24) IN ADVANCE OF THE FLUSHING TO WITNESS.
- PROVIDE AN APPROVED PICTORAL SIGN OF A STANDARDIZED DESIGN SHALL BE POSTED 6. ADJACENT TO EACH ELEVATOR CALL STATION ON ALL FLOORS INSTRUCTING OCCUPANTS TO USE THE EXIT STAIRWAYS AND NOT TO USE THE ELEVATOR IN CASE OF FIRE. THE SIGN SHALL READ: "IN FIRE EMERGENCY, DO NOT USE ELEVATOR, USE EXIT STAIRS."
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	PROJECT: THE RESERVE AT TINLEY PARK NORTHEAST CORNER OF OAK PARK AVENUE AND 183RD ST TINLEY PARK, IL	CLIENT: BUCKEYE COMMUNITY HOPE FOUNDATION 3021 EAST DUBLIN-GRANVILLE RD COLUMBUS OH 43231
	JOB NO. DATE FILE PLOT SCALE OWNER APPI	
-	Signature	Date
•		TITLE LL THIRD R PLAN
i	SHEET N	NUMBER 1.3

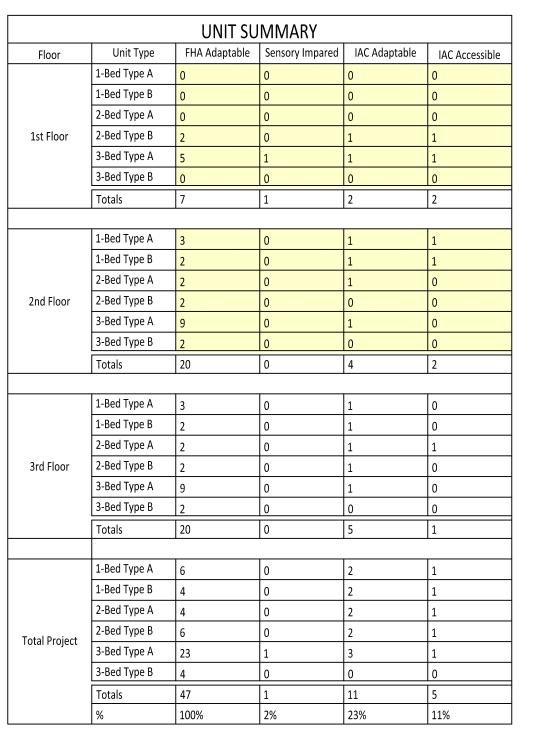

SCALE: 1" = 20'
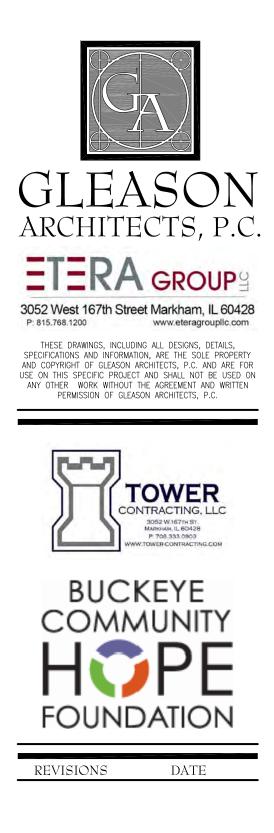
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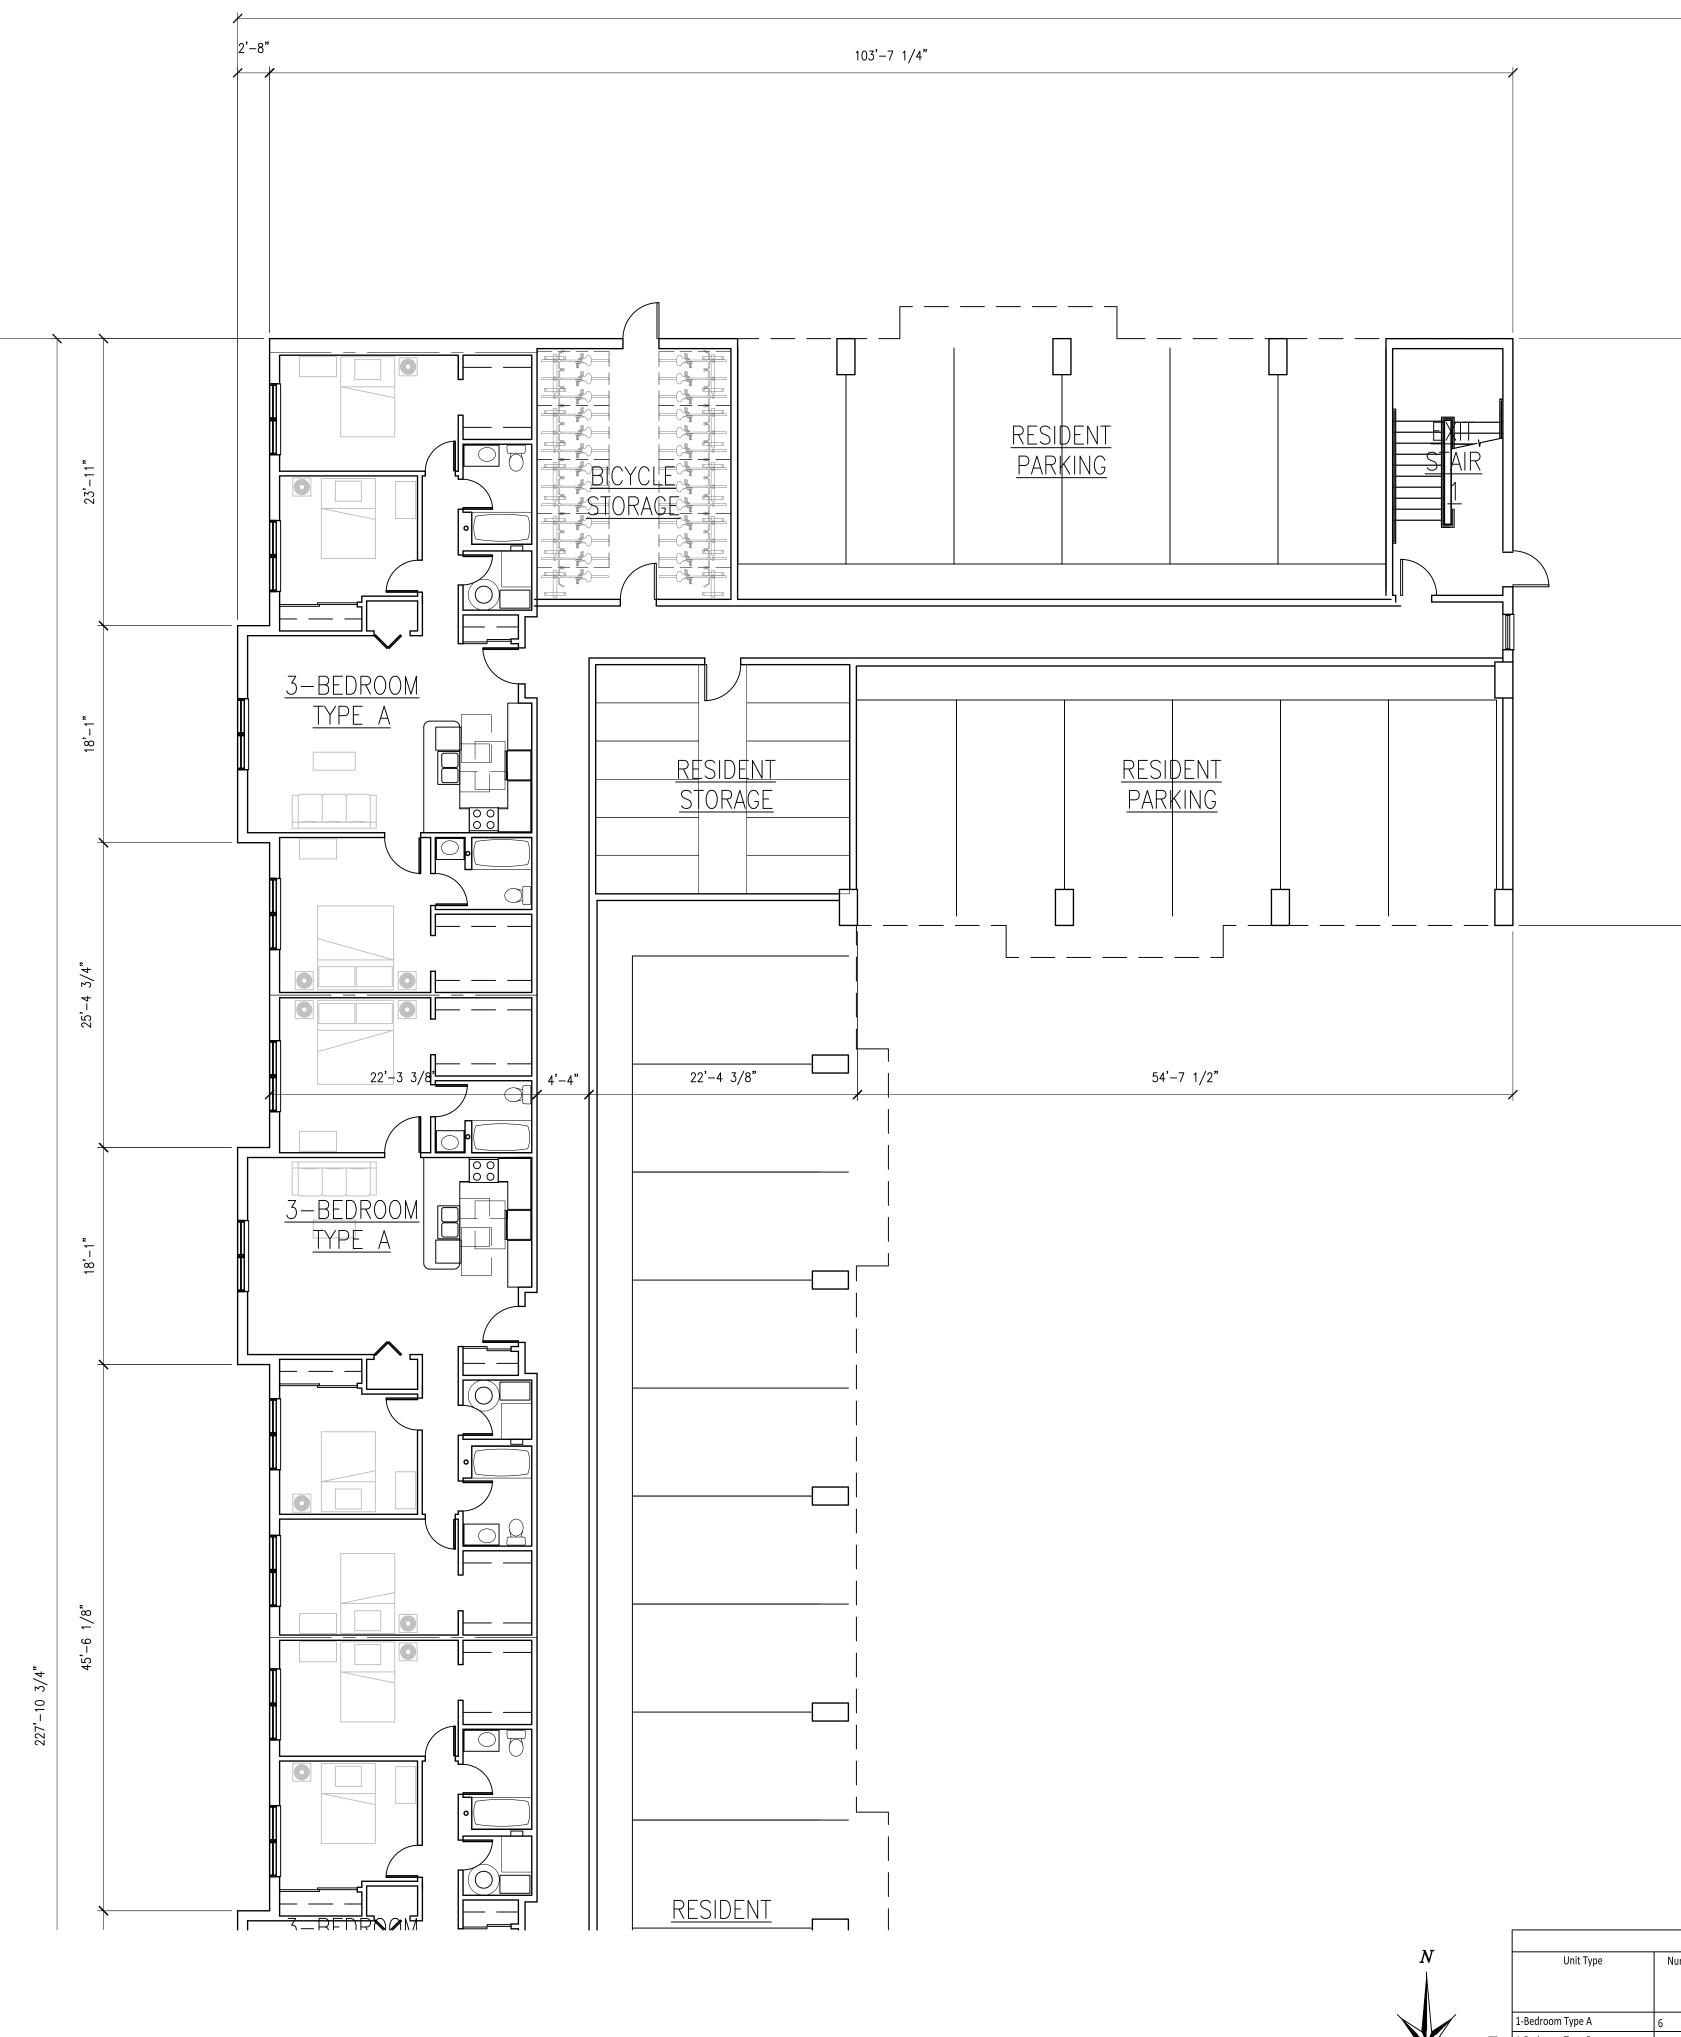


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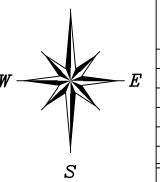
sheet number **A1-4**
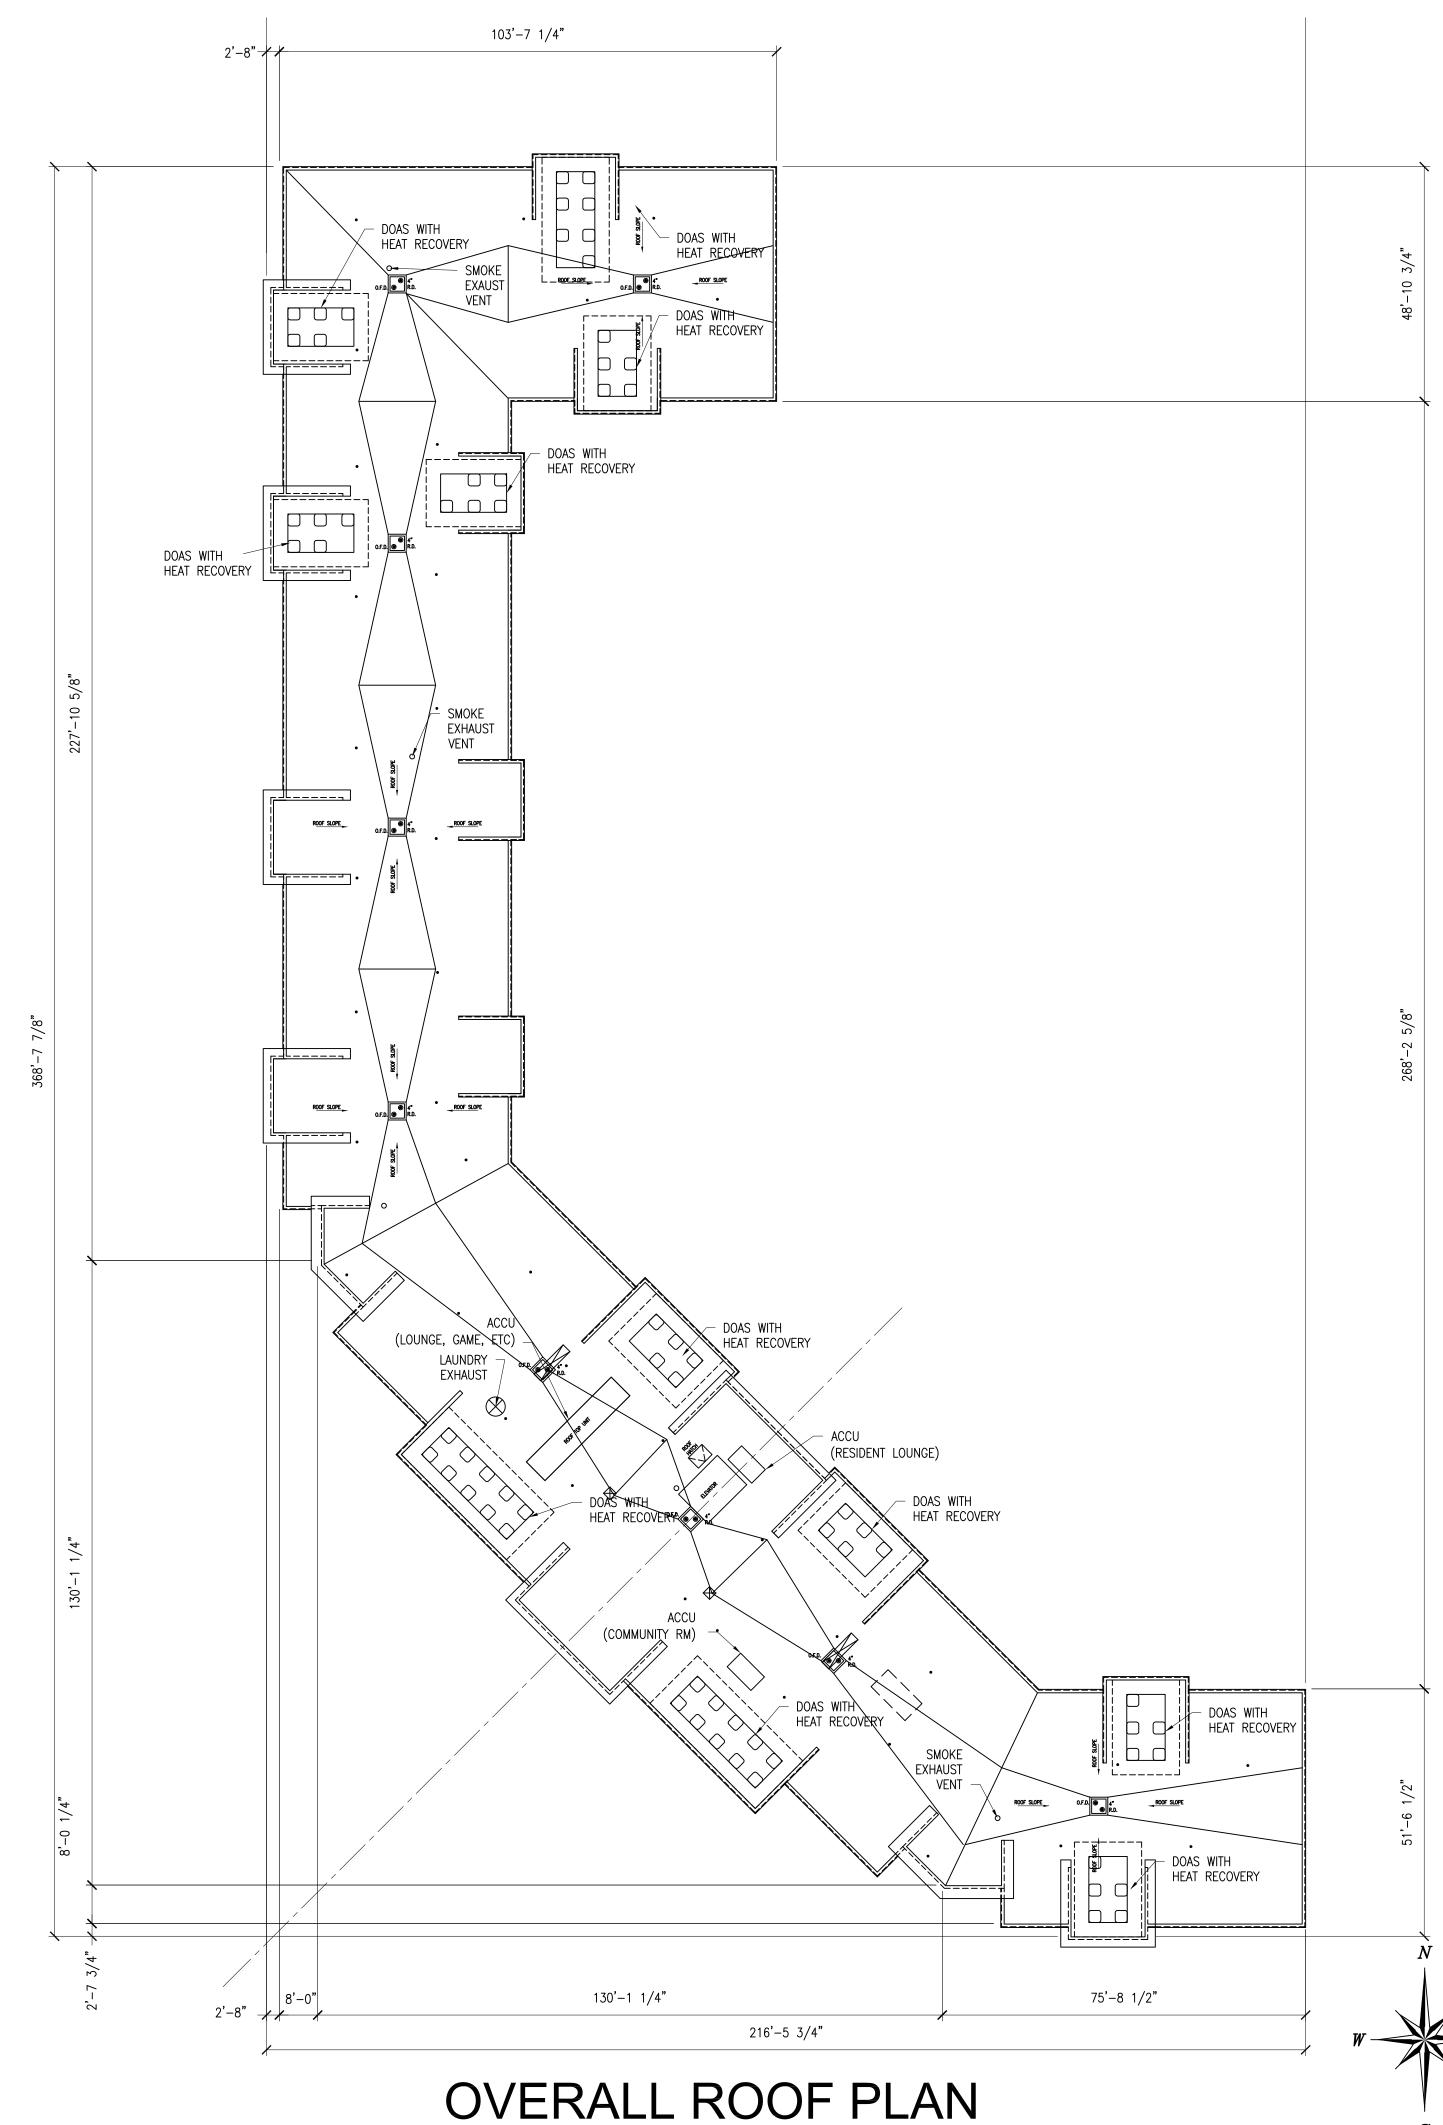
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ENLARGED FIRST FLOOR PLAN - NORTH



Unit Type	Number of
1-Bedroom Type A	6
1-Bedroom Type B	4
2-Bedroom Type A	4
2-Bedroom Type B	6
3-Bedroom Type A	23
3-Bedroom Type B	4
Total	47

- 1. ALL INTERIOR DIMENSIONS ARE TO FACE OF FINISH UNLESS NOTED OTHERWISE
- 2. ALL EXTERIOR DIMENSIONS ARE TO FACE OF FOUNDATION WALL UNLESS NOTED OTHERWISE
- 3. ALL STEEL COLUMNS SHALL RECEIVE SPRAY APPLIED FIREPROOFING UL # X752 1 HOUR RATING
- 4. THE GURNEE SIZED ELEVATOR (INDICATED ON THE PLAN) SHALL BE IDENTIFIED BY THE INTERNATION SYMBOL FOR EMERGENCY MEDICAL SERVICES (STAR OF LIFE). THE SYMBOL SHALL BE NOT LESS THAN THREE INCHES (3") HIGH AND SHALL BE PLACED ON BOTH SIDES OF THE HOIST WAY DOOR FRAME
- THE WATER MAIN SERVING THE FIRE SPRINKLER SYSTEM TO BE FLUSHED AT A RATE 5. APPRPRIATE TO ITS SIZE, PRIOR TO CONNECTION TO THE SYSTEM. NOTIFY THE LOCAL AUTHORITY TWENTY-FOUR HOURS (24) IN ADVANCE OF THE FLUSHING TO WITNESS.
- PROVIDE AN APPROVED PICTORAL SIGN OF A STANDARDIZED DESIGN SHALL BE POSTED 6. ADJACENT TO EACH ELEVATOR CALL STATION ON ALL FLOORS INSTRUCTING OCCUPANTS TO USE THE EXIT STAIRWAYS AND NOT TO USE THE ELEVATOR IN CASE OF FIRE. THE SIGN SHALL READ: "IN FIRE EMERGENCY, DO NOT USE ELEVATOR, USE EXIT STAIRS."
- PROVIDE A KEY BOX IF REQUIRED BY THE LOCAL AUTHORITY. VERIFY WITH THE AHJ THE 7. DEVICE REQUIREMENTS AND LOCATION
- ROOMS CONTAINING CONTROLS FOR AIR-CONDITIONING SYSTEMS, SPRINKLER RISERS, AND 8. VALVES, OR OTHER FIRE DETECTION, SUPPRESSION, OR CONTROL ELEMENTS SHALL BE IDENTIFIED WITH SIGNAGE OF DURABLE MATERIALS, PERMANENTLY INSTALLED, AND READILY VISIBLE.
- PROVIDE SIGNAGE ON DOORS OF ALL ELECTRICAL ROOMS CONTAINING CONTROL PANELS 9. STATING: "ELECTRICAL ROOM". REFER TO SHEET A10.4

Unit Type

1-Bed Type A 1-Bed Type B 2-Bed Type A 2-Bed Type B

3-Bed Type A 3-Bed Type B

1-Bed Type A 1-Bed Type B 2-Bed Type A

2-Bed Type B 3-Bed Type A 3-Bed Type B

Totals

1-Bed Type A 1-Bed Type B 2-Bed Type A

2-Bed Type B

3-Bed Type A 3-Bed Type B

1-Bed Type A 1-Bed Type B 2-Bed Type A 2-Bed Type B

3-Bed Type A 3-Bed Type B

Totals

Totals

Totals

Floor

1st Floor

2nd Floor

3rd Floor

Total Project



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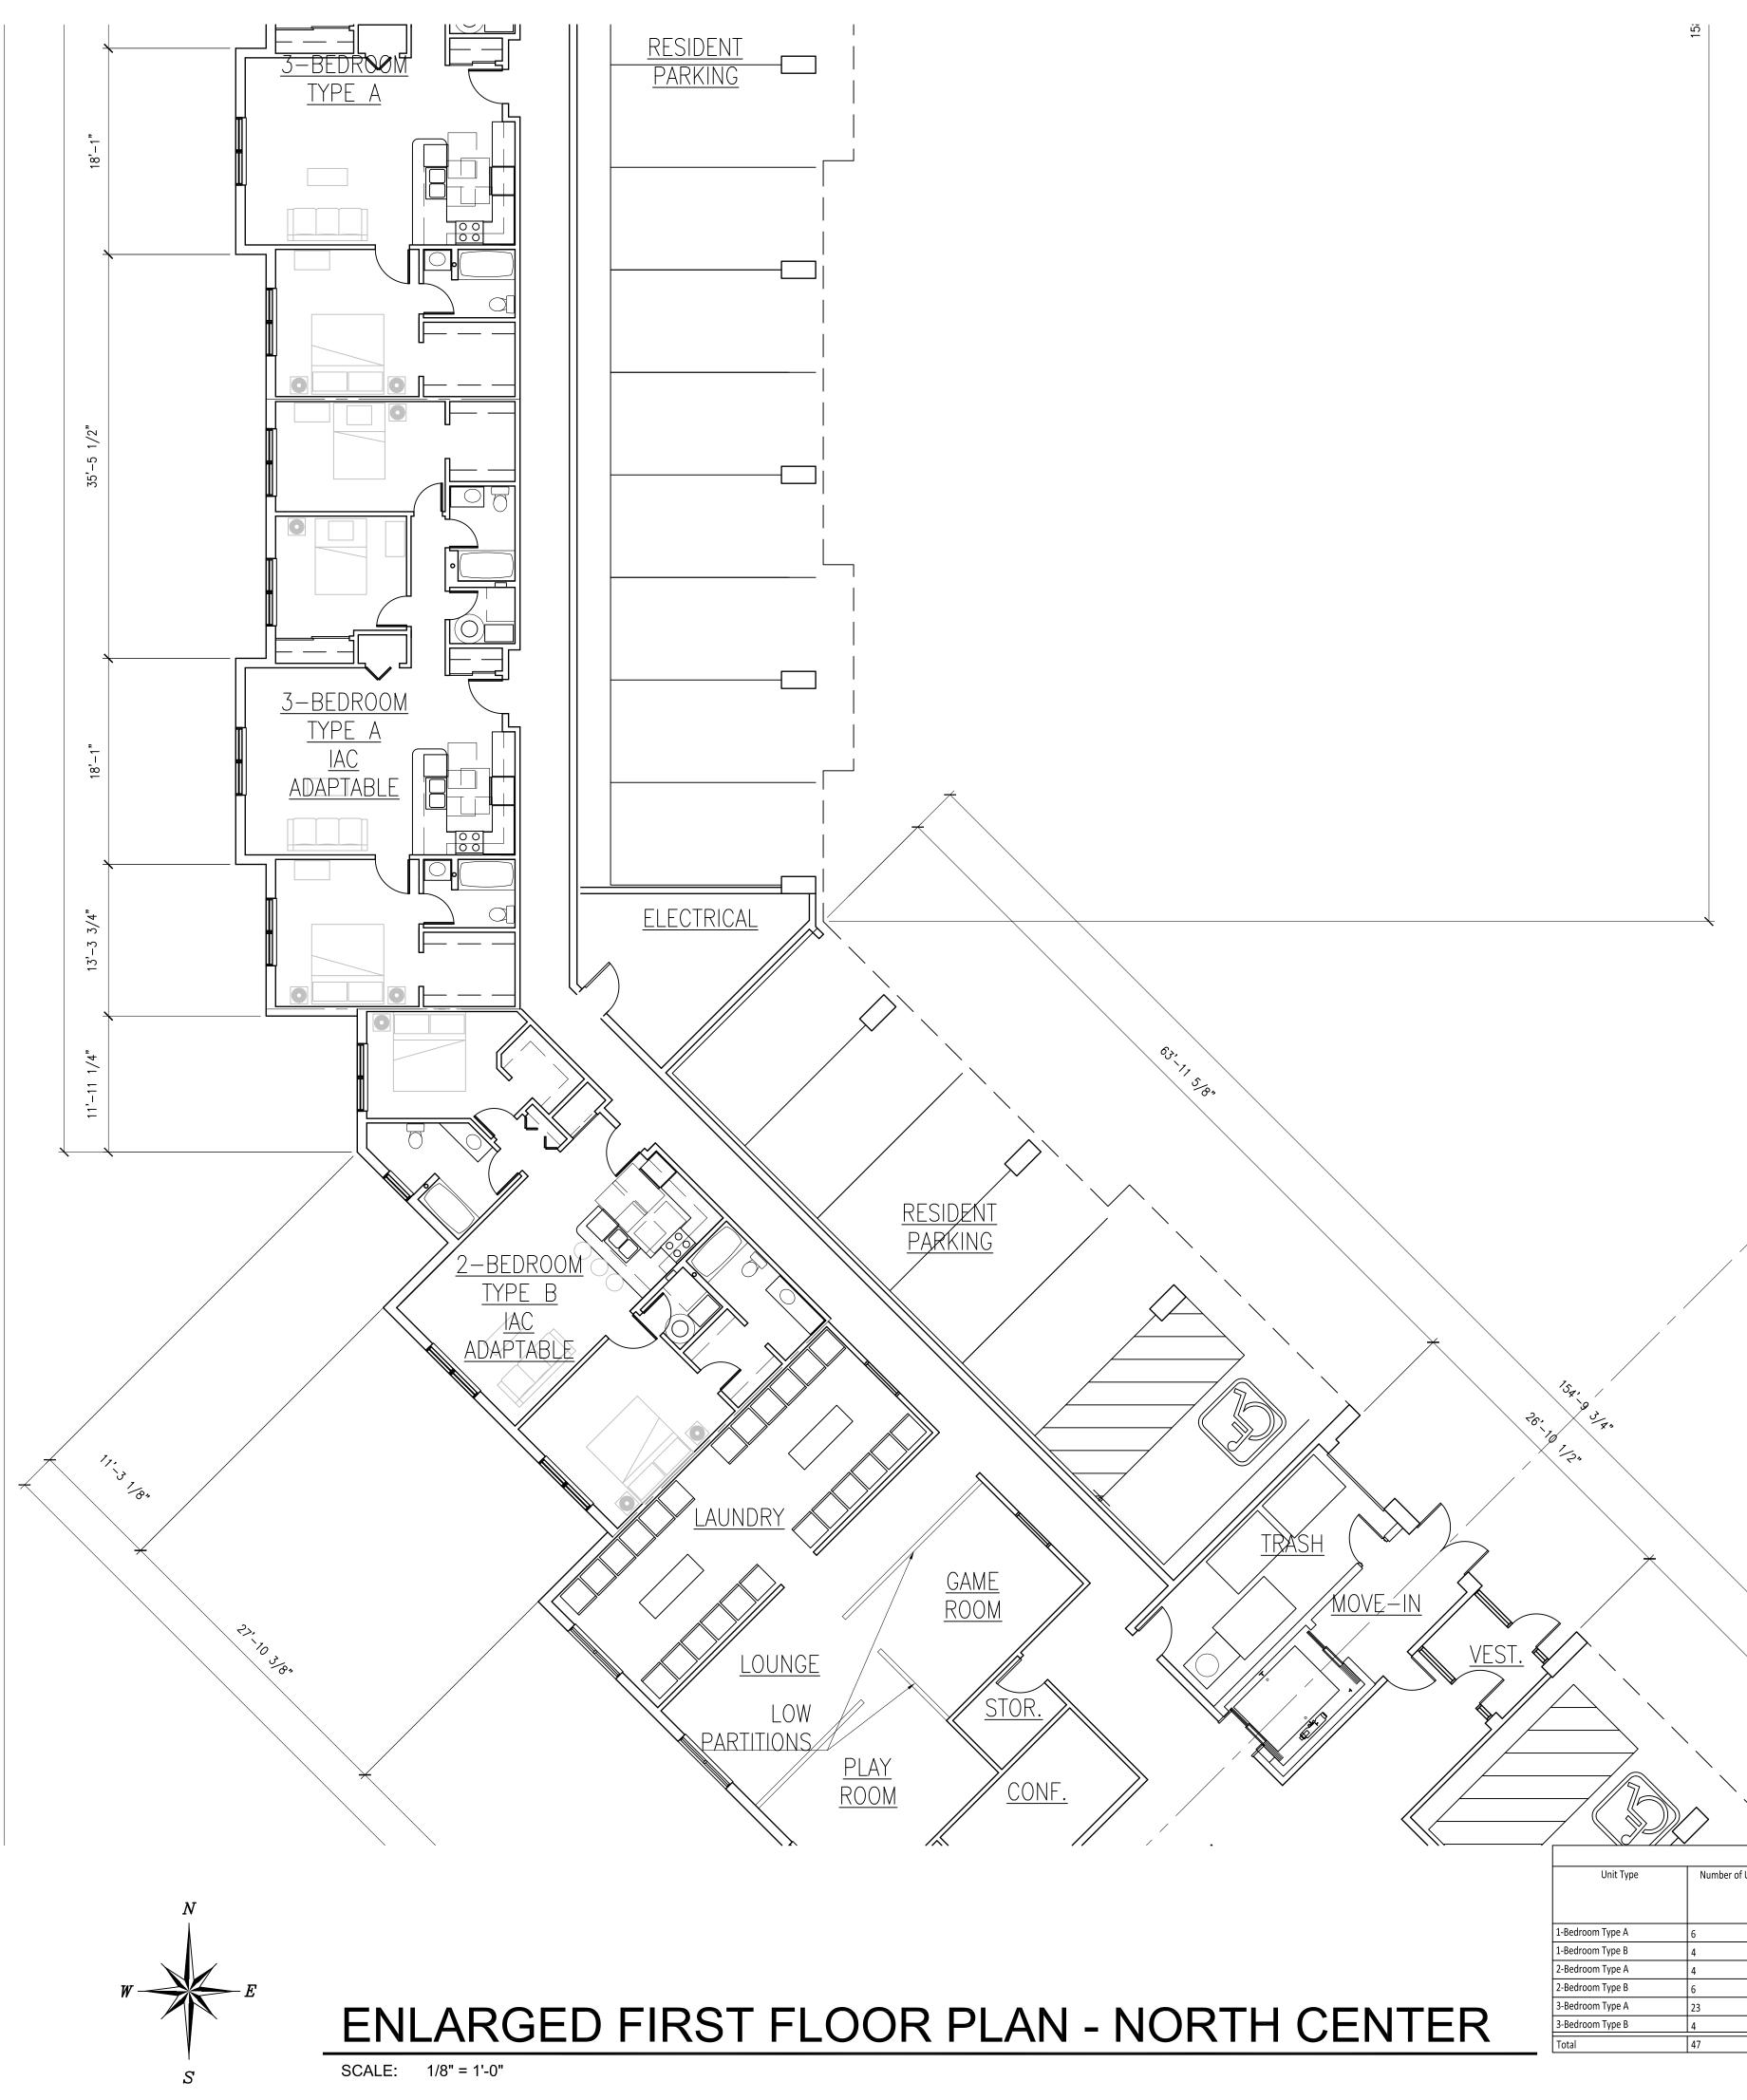
REVISIONS DATE

				THE RESERVE AT TINLEY PARK THE RESERVE AT TINLEY PARK NORTHEAST CORNER OF OAK PARK AVENUE AND 183RD ST TINLEY PARK, IL BUCKEYE COMMUNITY HOPE FOUNDATION 3021 EAST DUBLIN-GRANVILLE RD COLUMBUS OH 43231
UNIT SU	MMARY			N N
FHA Adaptable	Sensory Impared	IAC Adaptable	IAC Accessible	
0	0	0	0	A
0	0	0	0	ا لا کې لې
0	0	0	0	ROJECT: THE RESERVE AT TINLEY PARK VORTHEAST CORNER OF OAK PARK INLEY PARK, IL UCKEYE COMMUNITY HOPE FOUNDATION 021 EAST DUBLIN-GRANVILLE RD 021 EAST DUBLIN-GRANVILLE RD 021 EAST DUBLIN-GRANVILLE RD 021 EAST DUBLIN-GRANVILLE RD 021 EAST DUBLIN-GRANVILLE RD
2	0	1	1	
5	1	1	1	
0	0	0	0	
7	1	2	2	
1				PROJECT: THE RESERVE AT TINLEY P NORTHEAST CORNER OF OAK TINLEY PARK, IL CLIENT: BUCKEYE COMMUNITY HOPE FOUNDATION 3021 EAST DUBLIN-GRANVILLE RD COLUMBUS OH 43231
3	0	1	1	
2	0	1	1	
2	0	1	0	H H H H H H H H H H H H H H H H H H H
2	0	0	0	
9	0	1	0	
2	0	0	0	
20	0	4	2	PROJECT: THE RESERVE NORTHEAST CO TINLEY PARK, IL BUCKEYE COMMUNITY 3021 EAST DUBLIN-GRV COLUMBUS OH 43231
1	1		1	PROJECT: THE NORT TINLE BUCKEY COLUMI
3	0	1	0	
2	0	1	0	
2	0	1	1	
2	0	1	0	JOB NO. 15–016
9	0	1	0	DATE 1–11–16
2	0	0	0	FILE A2-1-1
20	0	5	1	PLOT SCALE 1:1
				OWNER APPROVAL
6	0	2	1	
4	0	2	1	
4	0	2	1	Signature
6	0	2	1	
23	1	3	1	Date
4	0	0	0	
47 100%	1 2%	11 23%	5	SHEET TITLE
100/0	۲ <u>۷</u>	23/0	±±/0	ENLARGED FIRST

IRST FLOOR PLAN NORTH

RESIDENT STORAGE							
r of Units	Storage Space Required Per IHDA (cu ft)	Storage Space Required Per Tinley Park (cu ft)	Minimum Storage Space Required in Each Unit (cu ft)	Common Area Storage Space Required for Each Unit (cu ft)	Storage Space Provided in Unit (cu ft)	Common Area Storage Space Provided (cu ft)	Total Storage Space Provided (cu ft)
	72	150	50	100	88	218	306
	72	150	50	100	116	218	334
	128	200	67	133	80	218	298
	128	200	67	133	79	218	297
	200	250	84	166	85	218	303
	200	250	84	166	85	218	303

SHEET NUMBER A2.1.1



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Unit Type	Number of
1-Bedroom Type A	6
1-Bedroom Type B	4
2-Bedroom Type A	4
2-Bedroom Type B	6
3-Bedroom Type A	23
3-Bedroom Type B	4
Total	47

- 1. ALL INTERIOR DIMENSIONS ARE TO FACE OF FINISH UNLESS NOTED OTHERWISE
- ALL EXTERIOR DIMENSIONS ARE TO FACE OF FOUNDATION WALL UNLESS NOTED OTHERWISE 2.
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- 4. THE GURNEE SIZED ELEVATOR (INDICATED ON THE PLAN) SHALL BE IDENTIFIED BY THE INTERNATION SYMBOL FOR EMERGENCY MEDICAL SERVICES (STAR OF LIFE). THE SYMBOL SHALL BE NOT LESS THAN THREE INCHES (3") HIGH AND SHALL BE PLACED ON BOTH SIDES OF THE HOIST WAY DOOR FRAME
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- 9 PROVIDE SIGNAGE ON DOORS OF ALL ELECTRICAL ROOMS CONTAINING CONTROL PANELS STATING: "ELECTRICAL ROOM". REFER TO SHEET A10.4



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	1		MMARY		1
Floor	Unit Type	FHA Adaptable	Sensory Impared	IAC Adaptable	IAC Accessib
	1-Bed Type A	0	0	0	0
	1-Bed Type B	0	0	0	0
	2-Bed Type A	0	0	0	0
1st Floor	2-Bed Type B	2	0	1	1
	3-Bed Type A	5	1	1	1
	3-Bed Type B	0	0	0	0
	Totals	7	1	2	2
	1-Bed Type A	3	0	1	1
	1-Bed Type B	2	0	1	1
	2-Bed Type A	2	0	1	0
2nd Floor	2-Bed Type B	2	0	0	0
	3-Bed Type A	9	0	1	0
	3-Bed Type B	2	0	0	0
	Totals	20	0	4	2
	•			•	•
	1-Bed Type A	3	0	1	0
	1-Bed Type B	2	0	1	0
	2-Bed Type A	2	0	1	1
3rd Floor	2-Bed Type B	2	0	1	0
	3-Bed Type A	9	0	1	0
	3-Bed Type B	2	0	0	0
	Totals	20	0	5	1
	1-Bed Type A	6	0	2	1
	1-Bed Type B	4	0	2	1
	2-Bed Type A	4	0	2	1
Tatal Desiles?	2-Bed Type B	6	0	2	1
Total Project	3-Bed Type A	23	1	3	1
	3-Bed Type B	4	0	0	0
	Totals	47	1	11	5
	%	100%	2%	23%	11%

	PROJECT: THE RESERVE AT TINLEY PARK NORTHEAST CORNER OF OAK PARK A TINLEY PARK, IL	CLIENT: BUCKEYE COMMUNITY HOPE FOUNDATION 3021 EAST DUBLIN-GRANVILLE RD COLUMBUS OH 43231
	DATE 1 FILE A PLOT SCALE 1 OWNER APPR Signature	
Storage Space ovided (cu ft)	SHEET T ENLARGE FLOOR NORTH C	D FIRST PLAN
	sheet ni A2-'	

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RESIDENT STORAGE							
Units	Storage Space Required Per IHDA (cu ft)	Storage Space Required Per Tinley Park (cu ft)	Minimum Storage Space Required in Each Unit (cu ft)	Common Area Storage Space Required for Each Unit (cu ft)	Storage Space Provided in Unit (cu ft)	Common Area Storage Space Provided (cu ft)	Total Storage Space Provided (cu ft)
	72	150	50	100	88	218	306
	72	150	50	100	116	218	334
	128	200	67	133	80	218	298
	128	200	67	133	79	218	297
	200	250	84	166	85	218	303
	200	250	84	166	85	218	303





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- 9 PROVIDE SIGNAGE ON DOORS OF ALL ELECTRICAL ROOMS CONTAINING CONTROL PANELS STATING: "ELECTRICAL ROOM". REFER TO SHEET A10.4





		FLO
Common Area Storage Space Provided (cu ft)	Total Storage Space Provided (cu ft)	
218	306	
218	334	

298

297

303

		5	1	1 -	1 -
	3-Bed Type B	0	0	0	0
	Totals	7	1	2	2
				•	
	1-Bed Type A	3	0	1	1
	1-Bed Type B	2	0	1	1
	2-Bed Type A	2	0	1	0
2nd Floor	2-Bed Type B	2	0	0	0
	3-Bed Type A	9	0	1	0
	3-Bed Type B	2	0	0	0
	Totals	20	0	4	2
	•	•	•	•	
	1-Bed Type A	3	0	1	0
	1-Bed Type B	2	0	1	0
	2-Bed Type A	2	0	1	1
3rd Floor	2-Bed Type B	2	0	1	0
	3-Bed Type A	9	0	1	0
	3-Bed Type B	2	0	0	0
	Totals	20	0	5	1
		•			
	1-Bed Type A	6	0	2	1
	1-Bed Type B	4	0	2	1
	2-Bed Type A	4	0	2	1
Tatal Dualant	2-Bed Type B	6	0	2	1
Total Project	3-Bed Type A	23	1	3	1
	3-Bed Type B	4	0	0	0
	Totals	47	1	11	5
	%	100%	2%	23%	11%
		1	1		
RESIDI	ENT STORAGE				
rage Space red Per Tinley	Minimum Storage Space Required in	Common Area Storage Space	Storage Space Provided in Unit (Common Ar cu Storage Spa	

UNIT SUMMARY

Floor

1st Floor

Unit Type

1-Bed Type A

1-Bed Type B 2-Bed Type A

2-Bed Type B

3-Bed Type A

Each Unit (cu ft)

(cu ft)

128

128

Park (cu ft)

150

150

200

250

Required for Each

. Unit (cu ft)

100

100

133


ft)

218

116

FHA Adaptable Sensory Impared IAC Adaptable IAC Accessible

SHEET NUMBER A2.1.3

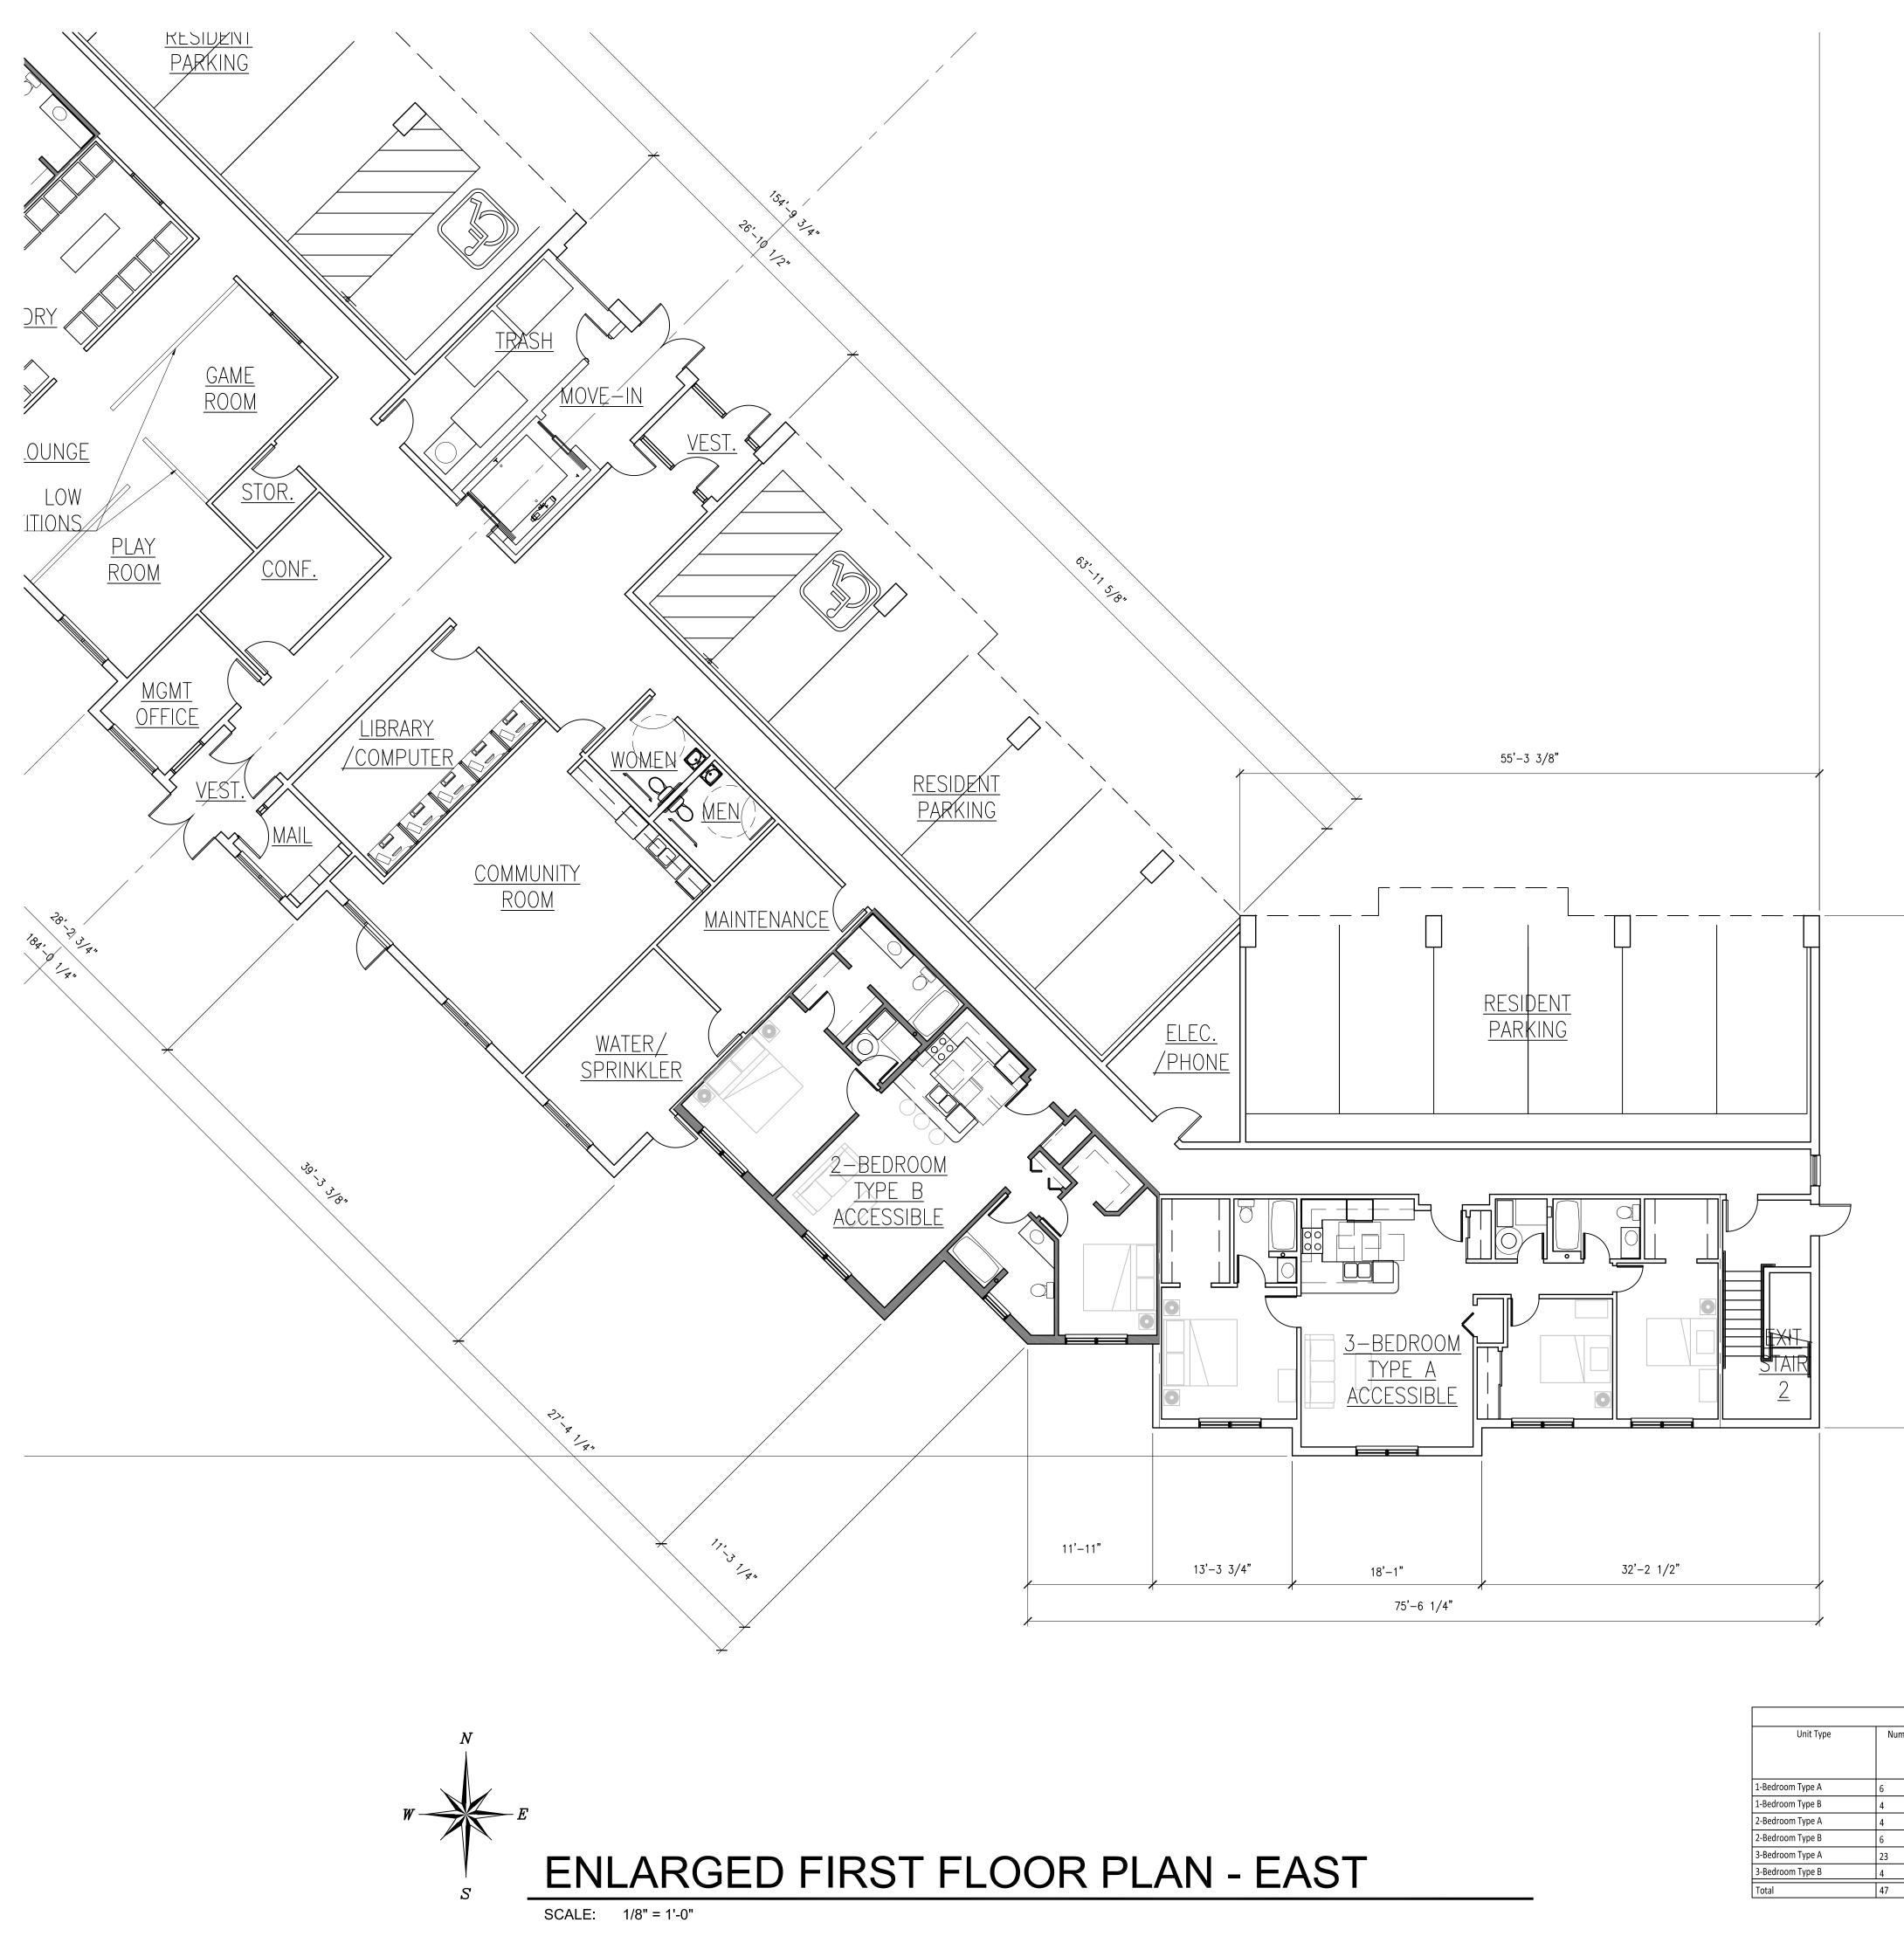

Number of
6
4
4
6
23
4
47

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- 9. PROVIDE SIGNAGE ON DOORS OF ALL ELECTRICAL ROOMS CONTAINING CONTROL PANELS STATING: "ELECTRICAL ROOM". REFER TO SHEET A10.4



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		UNIT SL	IMMARY		
Floor	Unit Type	FHA Adaptable	Sensory Impared	IAC Adaptable	IAC Accessible
	1-Bed Type A	0	0	0	0
	1-Bed Type B	0	0	0	0
	2-Bed Type A	0	0	0	0
1st Floor	2-Bed Type B	2	0	1	1
	3-Bed Type A	5	1	1	1
	3-Bed Type B	0	0	0	0
	Totals	7	1	2	2
	•			•	
	1-Bed Type A	3	0	1	1
	1-Bed Type B	2	0	1	1
	2-Bed Type A	2	0	1	0
2nd Floor	2-Bed Type B	2	0	0	0
	3-Bed Type A	9	0	1	0
	3-Bed Type B	2	0	0	0
	Totals	20	0	4	2
				•	ł.
	1-Bed Type A	3	0	1	0
	1-Bed Type B	2	0	1	0
	2-Bed Type A	2	0	1	1
3rd Floor	2-Bed Type B	2	0	1	0
	3-Bed Type A	9	0	1	0
	3-Bed Type B	2	0	0	0
	Totals	20	0	5	1
		1	•	•	
	1-Bed Type A	6	0	2	1
	1-Bed Type B	4	0	2	1
	2-Bed Type A	4	0	2	1
Total Project	2-Bed Type B	6	0	2	1
iolai riojett	3-Bed Type A	23	1	3	1
	3-Bed Type B	4	0	0	0
	Totals	47	1	11	5
	%	100%	2%	23%	11%

PROJECT: THE RESERVE AT TINLEY PARK NORTHEAST CORNER OF OAK PARK AVENUE AN TINLEY PARK, IL	CLIENT: BUCKEYE COMMUNITY HOPE FOUNDATION 3021 EAST DUBLIN-GRANVILLE RD COLUMBUS OH 43231			
FILE PLOT SCALE	15–016 1–11–16 A2.1.4 1:1 2OVAL			
Signature	Date			
SHEET TITLE ENLARGED FIRST FLOOR PLAN EAST				

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RESIDENT STORAGE								
of Units	Storage Space Required Per IHDA (cu ft)	Storage Space Required Per Tinley Park (cu ft)	Minimum Storage Space Required in Each Unit (cu ft)	Common Area Storage Space Required for Each Unit (cu ft)	Storage Space Provided in Unit (cu ft)	Common Area Storage Space Provided (cu ft)	Total Storage Space Provided (cu ft)	
	72	150	50	100	88	218	306	
	72	150	50	100	116	218	334	
	128	200	67	133	80	218	298	
	128	200	67	133	79	218	297	
	200	250	84	166	85	218	303	
	200	250	84	166	85	218	303	



SCALE: 1/8" = 1'-0"

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	_	UNIT SU	IMMARY		
Floor	Unit Type	FHA Adaptable	Sensory Impared	IAC Adaptable	IAC Accessible
	1-Bed Type A	0	0	0	0
	1-Bed Type B	0	0	0	0
	2-Bed Type A	0	0	0	0
1st Floor	2-Bed Type B	2	0	1	1
	3-Bed Type A	5	1	1	1
	3-Bed Type B	0	0	0	0
	Totals	7	1	2	2
		•		•	
	1-Bed Type A	3	0	1	1
	1-Bed Type B	2	0	1	1
	2-Bed Type A	2	0	1	0
2nd Floor	2-Bed Type B	2	0	0	0
	3-Bed Type A	9	0	1	0
	3-Bed Type B	2	0	0	0
	Totals	20	0	4	2
	1-Bed Type A	3	0	1	0
	1-Bed Type B	2	0	1	0
	2-Bed Type A	2	0	1	1
3rd Floor	2-Bed Type B	2	0	1	0
	3-Bed Type A	9	0	1	0
	3-Bed Type B	2	0	0	0
	Totals	20	0	5	1
	1-Bed Type A	6	0	2	1
	1-Bed Type B	4	0	2	1
	2-Bed Type A	4	0	2	1
Total Project	2-Bed Type B	6	0	2	1
Totarroject	3-Bed Type A	23	1	3	1
	3-Bed Type B	4	0	0	0
	Totals	47	1	11	5
	%	100%	2%	23%	11%

(cu ft)

128

128


Park (cu ft)

150

200


250

	12 200	0	0	2	1 -		
	1-Bed Type B	4	0	2	1		
	2-Bed Type A	4	0	2	1		
tal Projec	2-Bed Type B	6	0	2	1		Signature
lai Piojet	3-Bed Type A	23	1	3	1		Ī
	3-Bed Type B	4	0	0	0		L
	Totals	47	1	11	5		
	%	100%	2%	23%	11%		SHEET T
							ENLARGED
RESID	DENT STORAGE						
Space er Tinley u ft)	Minimum Storage Space Required in Each Unit (cu ft)	Common Area Storage Space Required for Each Unit (cu ft)	Storage Space Provided in Unit (c ft)	u Storage Space Provided (cu	ce	Total Storage Spa Provided (cu ft)	
	50	100	88	218		306	
	50	100	116	218		334	
	67	133	80	218		298	SHEET NU
	67	133	79	218		297	
	84	166	85	218		303	$\square AZ.$
	84	166	85	218		303	

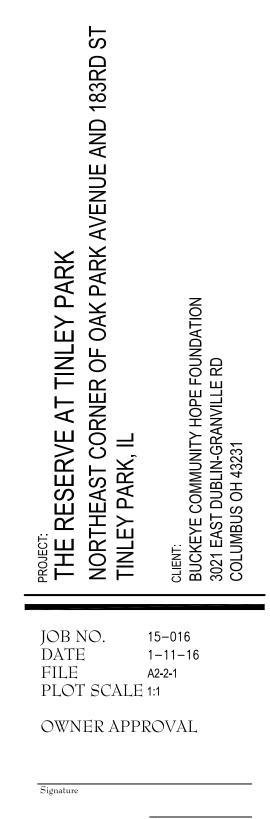

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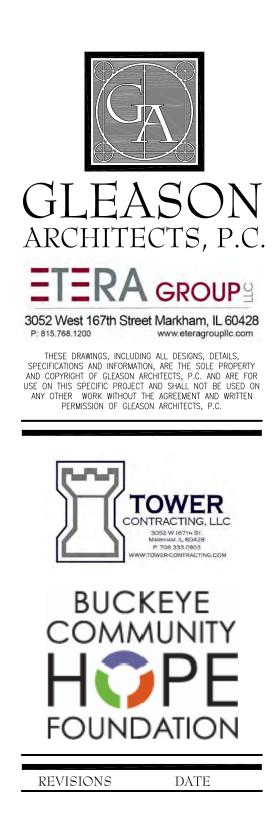
NUMBER .2.1

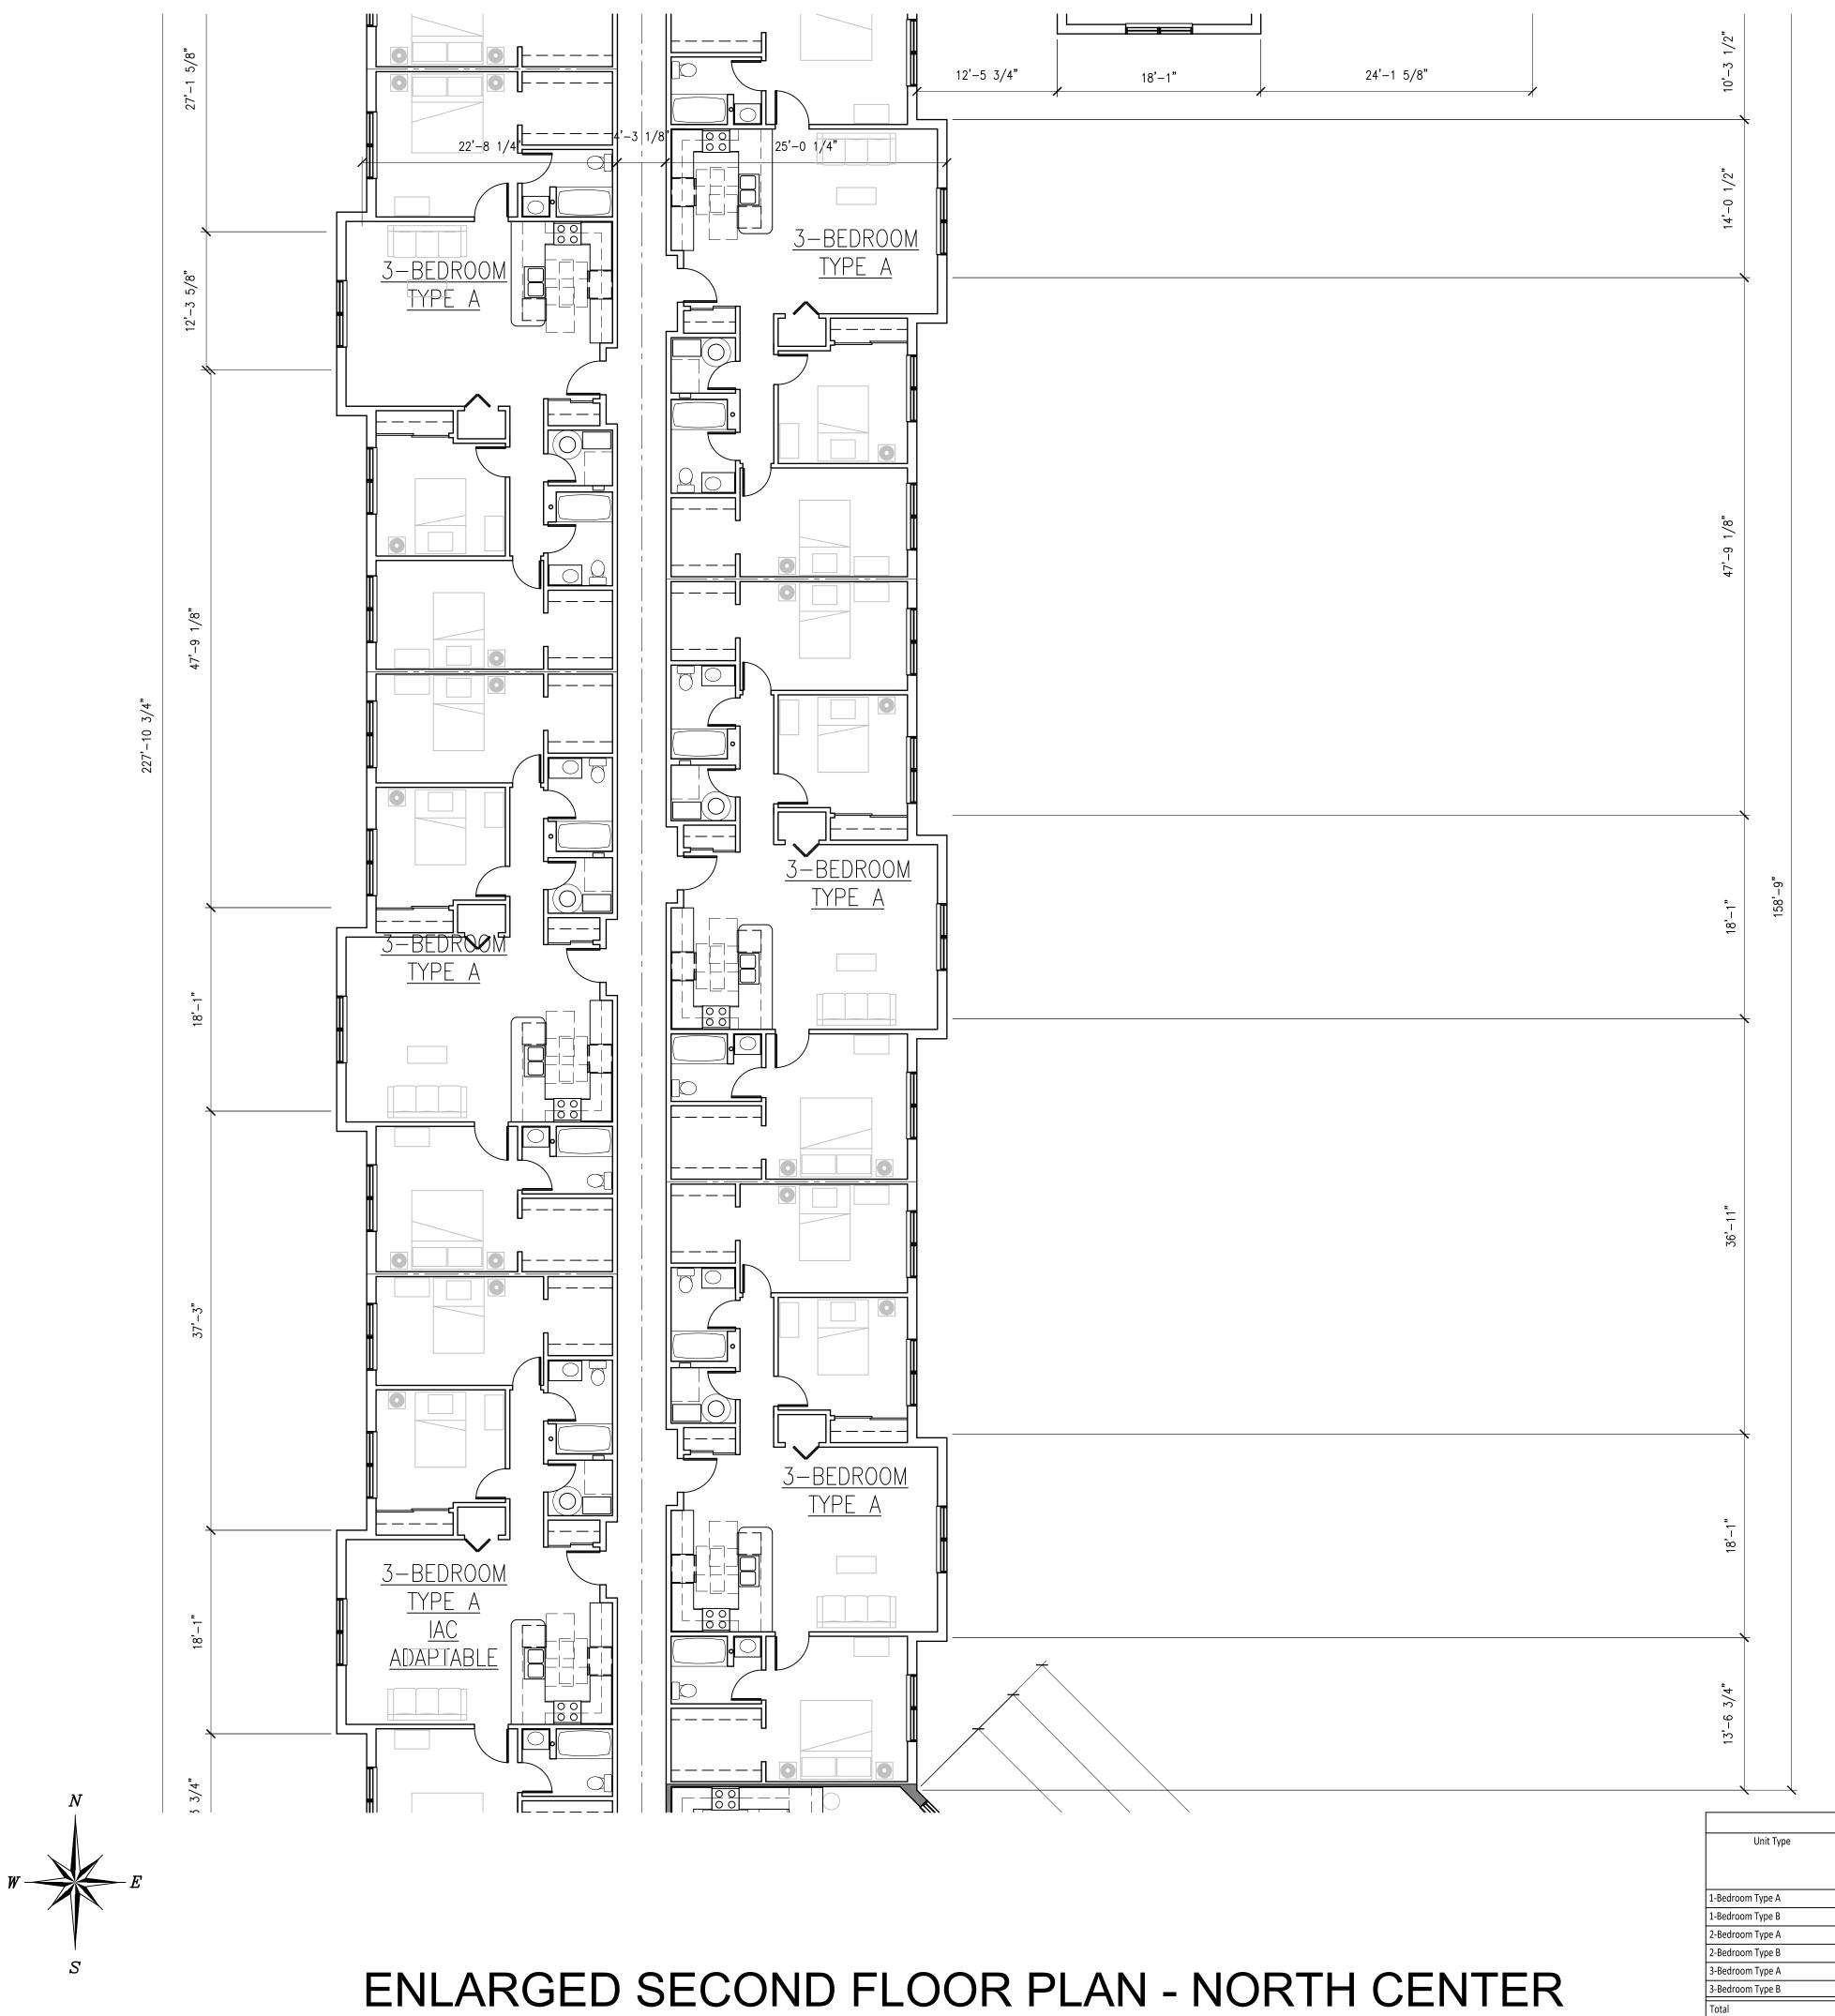

SCALE: 1/8" = 1'-0"

Number of Units
6
4
4
6
23
4
47

- 1. ALL INTERIOR DIMENSIONS ARE TO FACE OF FINISH UNLESS NOTED OTHERWISE
- ALL EXTERIOR DIMENSIONS ARE TO FACE OF FOUNDATION WALL UNLESS NOTED OTHERWISE 2.
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- 4. THE GURNEE SIZED ELEVATOR (INDICATED ON THE PLAN) SHALL BE IDENTIFIED BY THE INTERNATION SYMBOL FOR EMERGENCY MEDICAL SERVICES (STAR OF LIFE). THE SYMBOL SHALL BE NOT LESS THAN THREE INCHES (3") HIGH AND SHALL BE PLACED ON BOTH SIDES OF THE HOIST WAY DOOR FRAME
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- PROVIDE AN APPROVED PICTORAL SIGN OF A STANDARDIZED DESIGN SHALL BE POSTED 6. ADJACENT TO EACH ELEVATOR CALL STATION ON ALL FLOORS INSTRUCTING OCCUPANTS TO USE THE EXIT STAIRWAYS AND NOT TO USE THE ELEVATOR IN CASE OF FIRE. THE SIGN SHALL READ: "IN FIRE EMERGENCY, DO NOT USE ELEVATOR, USE EXIT STAIRS."
- PROVIDE A KEY BOX IF REQUIRED BY THE LOCAL AUTHORITY. VERIFY WITH THE AHJ THE 7. DEVICE REQUIREMENTS AND LOCATION
- ROOMS CONTAINING CONTROLS FOR AIR-CONDITIONING SYSTEMS, SPRINKLER RISERS, AND 8. VALVES, OR OTHER FIRE DETECTION, SUPPRESSION, OR CONTROL ELEMENTS SHALL BE IDENTIFIED WITH SIGNAGE OF DURABLE MATERIALS, PERMANENTLY INSTALLED, AND READILY VISIBLE.
- 9 PROVIDE SIGNAGE ON DOORS OF ALL ELECTRICAL ROOMS CONTAINING CONTROL PANELS STATING: "ELECTRICAL ROOM". REFER TO SHEET A10.4



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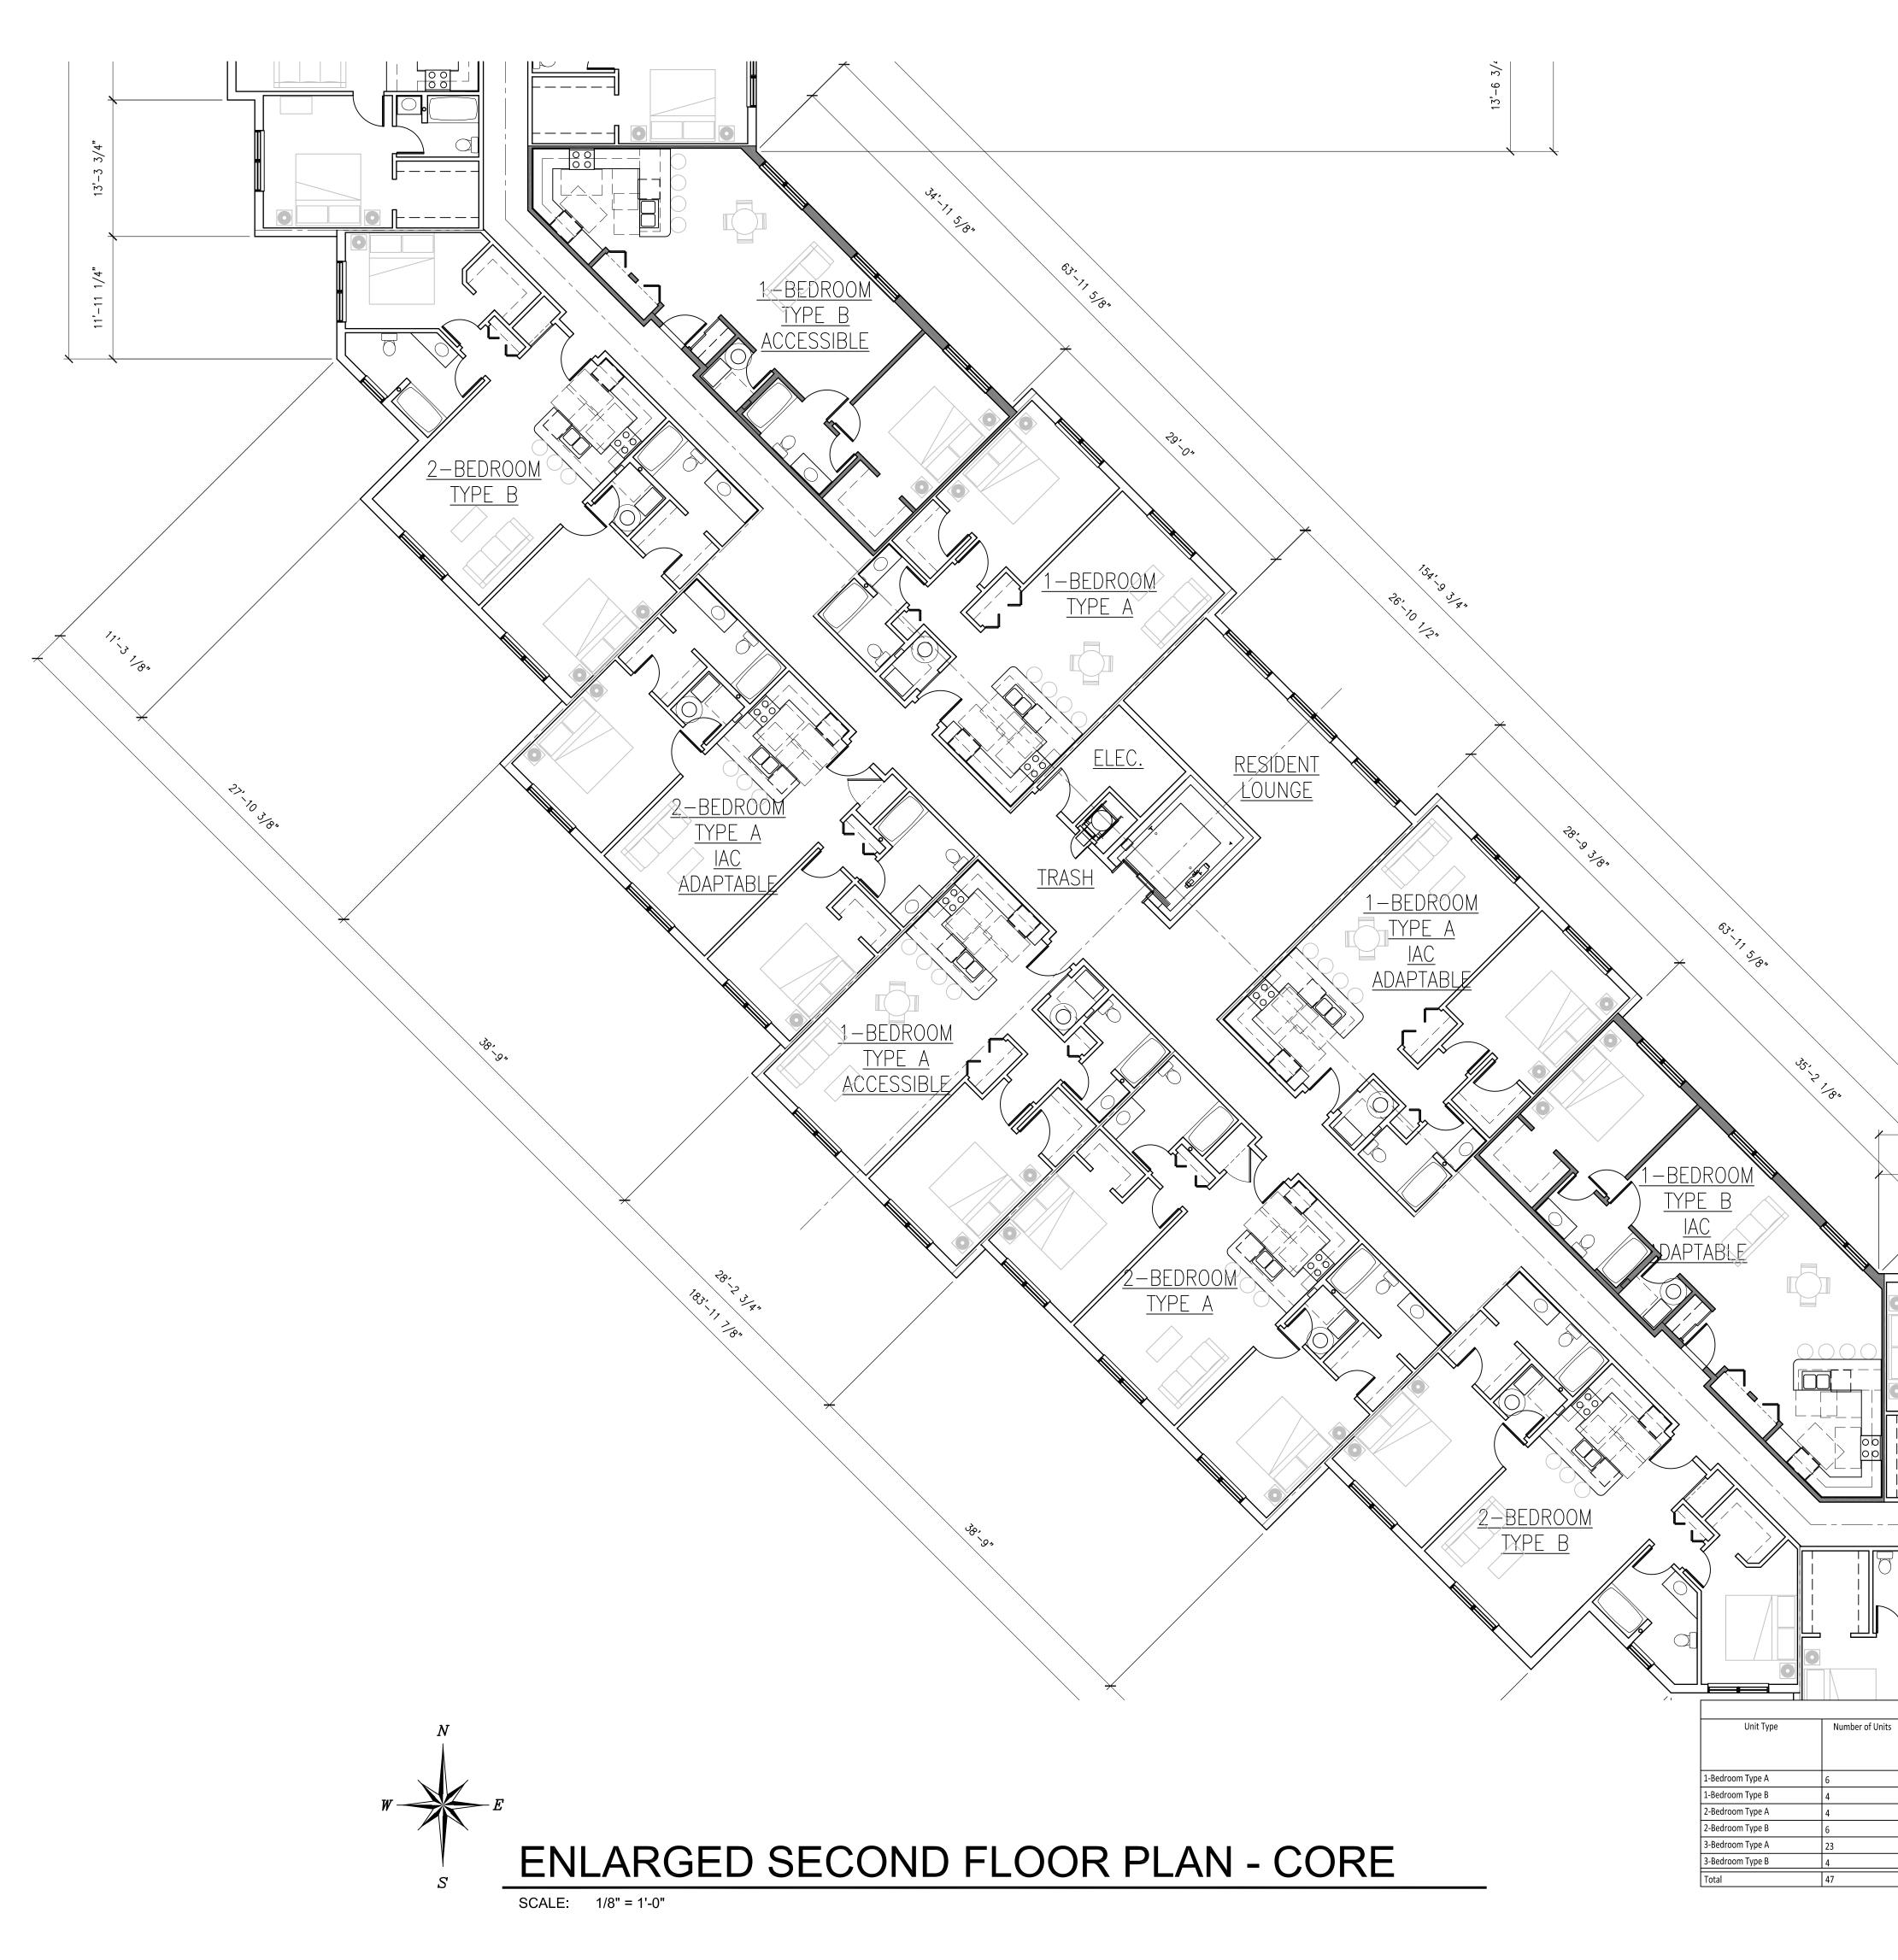
		UNIT SU	IMMARY								
Floor											
	1-Bed Type A	0	0	0	0						
	1-Bed Type B	0	0	0	0						
	2-Bed Type A	0	0	0	0						
st Floor	2-Bed Type B	2	0	1	1						
	3-Bed Type A	5	1	1	1						
	3-Bed Type B	0	0	0	0						
	Totals	7	1	2	2						
	1-Bed Type A	3	0	1	1						
	1-Bed Type B	2	0	1	1						
	2-Bed Type A	2	0	1	0						
nd Floor	2-Bed Type B	2	0	0	0						
	3-Bed Type A	9	0	1	0						
	3-Bed Type B	2	0	0	0						
	Totals	20	0	4	2						
	1-Bed Type A	3	0	1	0						
	1-Bed Type B	2	0	1	0						
	2-Bed Type A	2	0	1	1						
rd Floor	2-Bed Type B	2	0	1	0						
	3-Bed Type A	9	0	1	0						
	3-Bed Type B	2	0	0	0						
	Totals	20	0	5	1						
		-									
	1-Bed Type A	6	0	2	1						
	1-Bed Type B	4	0	2	1						
	2-Bed Type A	4	0	2	1						
al Project	2-Bed Type B	6	0	2	1						
	3-Bed Type A	23	1	3	1						
	3-Bed Type B	4	0	0	0						
	Totals	47	1	11	5						
	%	100%	2%	23%	11%						

PROJECT: THE RESERVE AT TINLEY PARK NORTHEAST CORNER OF OAK PARK AVENUE AND 183RD ST TINLEY PARK, IL	CLIENT: BUCKEYE COMMUNITY HOPE FOUNDATION 3021 EAST DUBLIN-GRANVILLE RD COLUMBUS OH 43231
DATE	
Signature	Date
SHEET	TITLE

RESIDENT STORAGE								
its	Storage Space Required Per IHDA (cu ft)	Storage Space Required Per Tinley Park (cu ft)	Minimum Storage Space Required in Each Unit (cu ft)	Common Area Storage Space Required for Each Unit (cu ft)	Storage Space Provided in Unit (cu ft)	Common Area Storage Space Provided (cu ft)	Total Storage Space Provided (cu ft)	
	72	150	50	100	88	218	306	
	72	150	50	100	116	218	334	
	128	200	67	133	80	218	298	
	128	200	67	133	79	218	297	
	200	250	84	166	85	218	303	
	200	250	84	166	85	218	303	



ENLARGED SECOND




- 1. ALL INTERIOR DIMENSIONS ARE TO FACE OF FINISH UNLESS NOTED OTHERWISE
- 2. ALL EXTERIOR DIMENSIONS ARE TO FACE OF FOUNDATION WALL UNLESS NOTED OTHERWISE
- 3. ALL STEEL COLUMNS SHALL RECEIVE SPRAY APPLIED FIREPROOFING UL # X752 1 HOUR RATING
- 4. THE GURNEE SIZED ELEVATOR (INDICATED ON THE PLAN) SHALL BE IDENTIFIED BY THE INTERNATION SYMBOL FOR EMERGENCY MEDICAL SERVICES (STAR OF LIFE). THE SYMBOL SHALL BE NOT LESS THAN THREE INCHES (3") HIGH AND SHALL BE PLACED ON BOTH SIDES OF THE HOIST WAY DOOR FRAME
- 5. THE WATER MAIN SERVING THE FIRE SPRINKLER SYSTEM TO BE FLUSHED AT A RATE APPRPRIATE TO ITS SIZE, PRIOR TO CONNECTION TO THE SYSTEM. NOTIFY THE LOCAL AUTHORITY TWENTY-FOUR HOURS (24) IN ADVANCE OF THE FLUSHING TO WITNESS.
- 6. PROVIDE AN APPROVED PICTORAL SIGN OF A STANDARDIZED DESIGN SHALL BE POSTED ADJACENT TO EACH ELEVATOR CALL STATION ON ALL FLOORS INSTRUCTING OCCUPANTS TO USE THE EXIT STAIRWAYS AND NOT TO USE THE ELEVATOR IN CASE OF FIRE. THE SIGN SHALL READ: "IN FIRE EMERGENCY, DO NOT USE ELEVATOR, USE EXIT STAIRS."
- 7. PROVIDE A KEY BOX IF REQUIRED BY THE LOCAL AUTHORITY. VERIFY WITH THE AHJ THE DEVICE REQUIREMENTS AND LOCATION
- ROOMS CONTAINING CONTROLS FOR AIR-CONDITIONING SYSTEMS, SPRINKLER RISERS, AND VALVES, OR OTHER FIRE DETECTION, SUPPRESSION, OR CONTROL ELEMENTS SHALL BE IDENTIFIED WITH SIGNAGE OF DURABLE MATERIALS, PERMANENTLY INSTALLED, AND READILY VISIBLE.
- 9. PROVIDE SIGNAGE ON DOORS OF ALL ELECTRICAL ROOMS CONTAINING CONTROL PANELS STATING: "ELECTRICAL ROOM". REFER TO SHEET A10.4



	1		MMARY	1	
Floor	Unit Type	FHA Adaptable	Sensory Impared	IAC Adaptable	IAC Accessible
11001	1-Bed Type A	0	0	0	0
	1-Bed Type B	0	0	0	0
	2-Bed Type A	0	0	0	0
1st Floor	2-Bed Type B	2	0	1	1
	3-Bed Type A	5	1	1	1
	3-Bed Type B	0	0	0	0
	Totals	7	1	2	2
	1-Bed Type A	3	0	1	1
	1-Bed Type B	2	0	1	1
	2-Bed Type A	2	0	1	0
2nd Floor	2-Bed Type B	2	0	0	0
	3-Bed Type A	9	0	1	0
	3-Bed Type B	2	0	0	0
	Totals	20	0	4	2
	1-Bed Type A	3	0	1	0
	1-Bed Type B	2	0	1	0
	2-Bed Type A	2	0	1	1
3rd Floor	2-Bed Type B	2	0	1	0
	3-Bed Type A	9	0	1	0
	3-Bed Type B	2	0	0	0
	Totals	20	0	5	1
	1-Bed Type A	6	0	2	1
	1-Bed Type B	4	0	2	1
	2-Bed Type A	4	0	2	1
Total Project	2-Bed Type B	6	0	2	1
iotai Piojett	3-Bed Type A	23	1	3	1
	3-Bed Type B	4	0	0	0
	Totals	47	1	11	5
	%	100%	2%	23%	11%


13'-6 3/4"

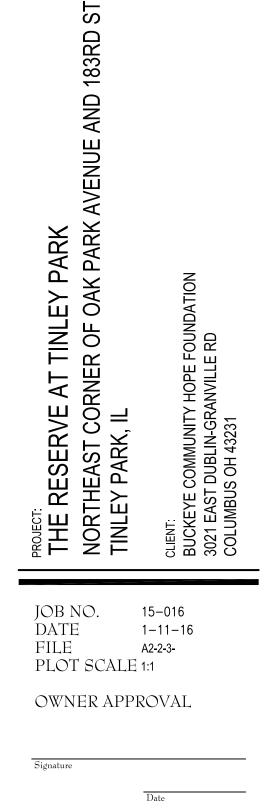

SHEET TITLE ENLARGED SECOND FLOOR PLAN CORE

sheet number **A2.2.3**

		RESIE	DENT STORAGE				
	Storage Space Required Per IHDA (cu ft)	Storage Space Required Per Tinley Park (cu ft)	Minimum Storage Space Required in Each Unit (cu ft)	Common Area Storage Space Required for Each Unit (cu ft)	Storage Space Provided in Unit (cu ft)	Common Area Storage Space Provided (cu ft)	Total Storage Space Provided (cu ft)
	72	150	50	100	88	218	306
	72	150	50	100	116	218	334
	128	200	67	133	80	218	298
	128	200	67	133	79	218	297
	200	250	84	166	85	218	303
	200	250	84	166	85	218	303
_							

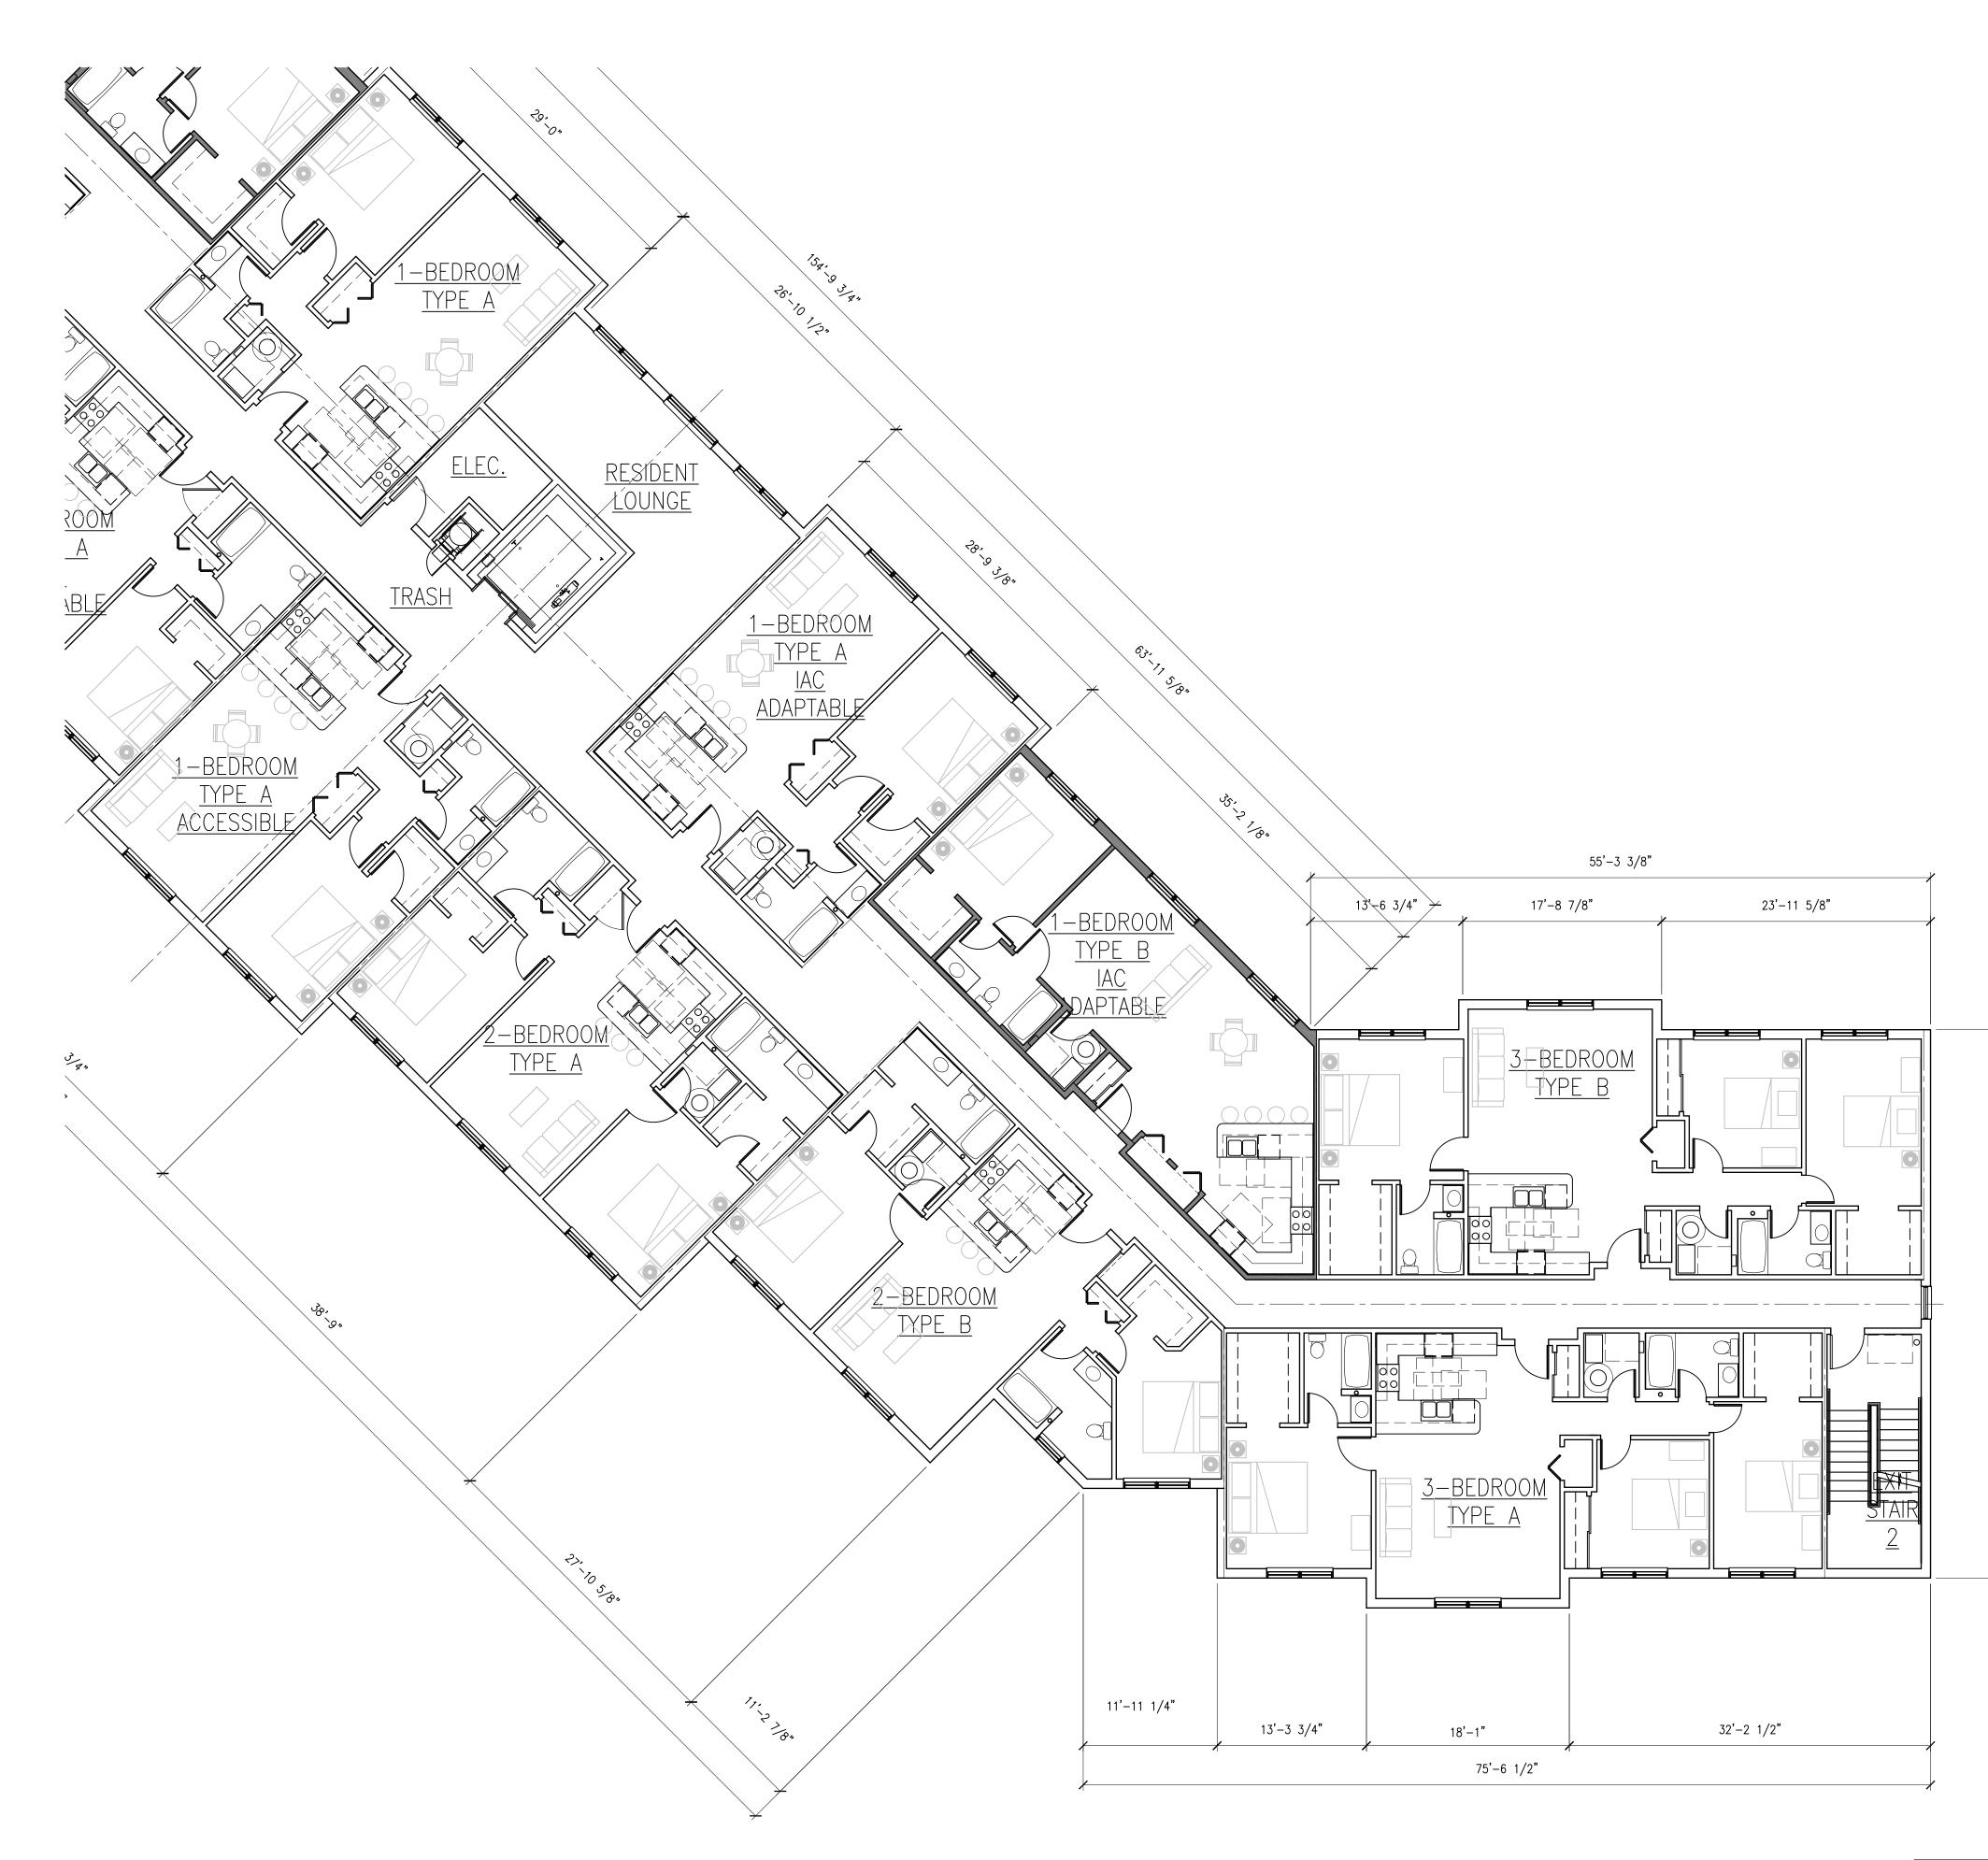



ENLARGED SECOND FLOOR PLAN - EAST

Unit Type	Number of U
1-Bedroom Type A	6
1-Bedroom Type B	4
2-Bedroom Type A	4
2-Bedroom Type B	6
3-Bedroom Type A	23
3-Bedroom Type B	4
Total	47


- 1. ALL INTERIOR DIMENSIONS ARE TO FACE OF FINISH UNLESS NOTED OTHERWISE
- 2. ALL EXTERIOR DIMENSIONS ARE TO FACE OF FOUNDATION WALL UNLESS NOTED OTHERWISE
- ALL STEEL COLUMNS SHALL RECEIVE SPRAY APPLIED FIREPROOFING UL # X752 1 HOUR 3. RATING
- 4. THE GURNEE SIZED ELEVATOR (INDICATED ON THE PLAN) SHALL BE IDENTIFIED BY THE INTERNATION SYMBOL FOR EMERGENCY MEDICAL SERVICES (STAR OF LIFE). THE SYMBOL SHALL BE NOT LESS THAN THREE INCHES (3") HIGH AND SHALL BE PLACED ON BOTH SIDES OF THE HOIST WAY DOOR FRAME
- THE WATER MAIN SERVING THE FIRE SPRINKLER SYSTEM TO BE FLUSHED AT A RATE 5. APPRPRIATE TO ITS SIZE, PRIOR TO CONNECTION TO THE SYSTEM. NOTIFY THE LOCAL AUTHORITY TWENTY-FOUR HOURS (24) IN ADVANCE OF THE FLUSHING TO WITNESS.
- PROVIDE AN APPROVED PICTORAL SIGN OF A STANDARDIZED DESIGN SHALL BE POSTED 6. ADJACENT TO EACH ELEVATOR CALL STATION ON ALL FLOORS INSTRUCTING OCCUPANTS TO USE THE EXIT STAIRWAYS AND NOT TO USE THE ELEVATOR IN CASE OF FIRE. THE SIGN SHALL READ: "IN FIRE EMERGENCY, DO NOT USE ELEVATOR, USE EXIT STAIRS."
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- ROOMS CONTAINING CONTROLS FOR AIR-CONDITIONING SYSTEMS, SPRINKLER RISERS, AND 8. VALVES, OR OTHER FIRE DETECTION, SUPPRESSION, OR CONTROL ELEMENTS SHALL BE IDENTIFIED WITH SIGNAGE OF DURABLE MATERIALS, PERMANENTLY INSTALLED, AND READILY VISIBLE.
- 9. PROVIDE SIGNAGE ON DOORS OF ALL ELECTRICAL ROOMS CONTAINING CONTROL PANELS STATING: "ELECTRICAL ROOM". REFER TO SHEET A10.4



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		UNIT SU	IMMARY		
Floor	Unit Type	FHA Adaptable	Sensory Impared	IAC Adaptable	IAC Accessible
	1-Bed Type A	0	0	0	0
	1-Bed Type B	0	0	0	0
	2-Bed Type A	0	0	0	0
1st Floor	2-Bed Type B	2	0	1	1
	3-Bed Type A	5	1	1	1
	3-Bed Type B	0	0	0	0
	Totals	7	1	2	2
	1-Bed Type A	3	0	1	1
	1-Bed Type B	2	0	1	1
	2-Bed Type A	2	0	1	0
2nd Floor	2-Bed Type B	2	0	0	0
	3-Bed Type A	9	0	1	0
	3-Bed Type B	2	0	0	0
	Totals	20	0	4	2
				1	
	1-Bed Type A	3	0	1	0
	1-Bed Type B	2	0	1	0
	2-Bed Type A	2	0	1	1
3rd Floor	2-Bed Type B	2	0	1	0
	3-Bed Type A	9	0	1	0
	3-Bed Type B	2	0	0	0
	Totals	20	0	5	1
				1	
	1-Bed Type A	6	0	2	1
	1-Bed Type B	4	0	2	1
	2-Bed Type A	4	0	2	1
Total Project	2-Bed Type B	6	0	2	1
	3-Bed Type A	23	1	3	1
	3-Bed Type B	4	0	0	0
	Totals	47	1	11	5
	%	100%	2%	23%	11%

	RESIDENT STORAGE								
nits	Storage Space Required Per IHDA (cu ft)	Storage Space Required Per Tinley Park (cu ft)	Minimum Storage Space Required in Each Unit (cu ft)	Common Area Storage Space Required for Each Unit (cu ft)	Storage Space Provided in Unit (cu ft)	Common Area Storage Space Provided (cu ft)	Total Storage Space Provided (cu ft)		
	72	150	50	100	88	218	306		
	72	150	50	100	116	218	334		
	128	200	67	133	80	218	298		
	128	200	67	133	79	218	297		
	200	250	84	166	85	218	303		
	200	250	84	166	85	218	303		

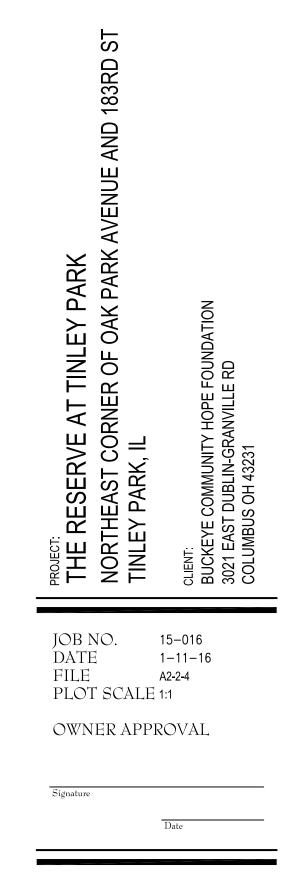


SHEET TITLE ENLARGED SECOND FLOOR PLAN EAST

SHEET NUMBER A2.2.4




SCALE: 1/8" = 1'-0"

ENLARGED THIRD FLOOR PLAN - NORTH

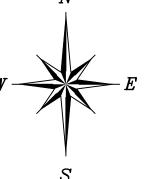

Unit Type	Number of
1-Bedroom Type A	6
1-Bedroom Type B	4
2-Bedroom Type A	4
2-Bedroom Type B	6
3-Bedroom Type A	23
3-Bedroom Type B	4
Total	47

- 1. ALL INTERIOR DIMENSIONS ARE TO FACE OF FINISH UNLESS NOTED OTHERWISE
- ALL EXTERIOR DIMENSIONS ARE TO FACE OF FOUNDATION WALL UNLESS NOTED OTHERWISE 2.
- ALL STEEL COLUMNS SHALL RECEIVE SPRAY APPLIED FIREPROOFING UL # X752 1 HOUR 3. RATING
- 4. THE GURNEE SIZED ELEVATOR (INDICATED ON THE PLAN) SHALL BE IDENTIFIED BY THE INTERNATION SYMBOL FOR EMERGENCY MEDICAL SERVICES (STAR OF LIFE). THE SYMBOL SHALL BE NOT LESS THAN THREE INCHES (3") HIGH AND SHALL BE PLACED ON BOTH SIDES OF THE HOIST WAY DOOR FRAME
- THE WATER MAIN SERVING THE FIRE SPRINKLER SYSTEM TO BE FLUSHED AT A RATE 5. APPRPRIATE TO ITS SIZE, PRIOR TO CONNECTION TO THE SYSTEM. NOTIFY THE LOCAL AUTHORITY TWENTY-FOUR HOURS (24) IN ADVANCE OF THE FLUSHING TO WITNESS.
- PROVIDE AN APPROVED PICTORAL SIGN OF A STANDARDIZED DESIGN SHALL BE POSTED 6. ADJACENT TO EACH ELEVATOR CALL STATION ON ALL FLOORS INSTRUCTING OCCUPANTS TO USE THE EXIT STAIRWAYS AND NOT TO USE THE ELEVATOR IN CASE OF FIRE. THE SIGN SHALL READ: "IN FIRE EMERGENCY, DO NOT USE ELEVATOR, USE EXIT STAIRS."
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- PROVIDE SIGNAGE ON DOORS OF ALL ELECTRICAL ROOMS CONTAINING CONTROL PANELS 9 STATING: "ELECTRICAL ROOM". REFER TO SHEET A10.4

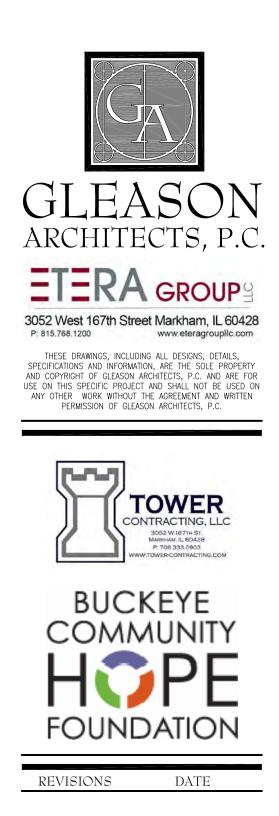

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		UNIT SU	IMMARY		
Floor	Unit Type	FHA Adaptable	Sensory Impared	IAC Adaptable	IAC Accessible
	1-Bed Type A	0	0	0	0
	1-Bed Type B	0	0	0	0
st Floor	2-Bed Type A	0	0	0	0
	2-Bed Type B	2	0	1	1
	3-Bed Type A	5	1	1	1
	3-Bed Type B	0	0	0	0
	Totals	7	1	2	2
	1-Bed Type A	3	0	1	1
	1-Bed Type B	2	0	1	1
	2-Bed Type A	2	0	1	0
nd Floor	2-Bed Type B	2	0	0	0
	3-Bed Type A	9	0	1	0
	3-Bed Type B	2	0	0	0
	Totals	20	0	4	2
	1-Bed Type A	3	0	1	0
	1-Bed Type B	2	0	1	0
	2-Bed Type A	2	0	1	1
rd Floor	2-Bed Type B	2	0	1	0
	3-Bed Type A	9	0	1	0
	3-Bed Type B	2	0	0	0
	Totals	20	0	5	1
				I	1
	1-Bed Type A	6	0	2	1
	1-Bed Type B	4	0	2	1
	2-Bed Type A	4	0	2	1
al Project	2-Bed Type B	6	0	2	1
,	3-Bed Type A	23	1	3	1
	3-Bed Type B	4	0	0	0
	Totals	47	1	11	5
	%	100%	2%	23%	11%

	PROJECT: THE RESERVE AT TINLEY PARK NORTHEAST CORNER OF OAK PARK AVENUE AND ' TINLEY PARK, IL	CLIENT: BUCKEYE COMMUNITY HOPE FOUNDATION 3021 EAST DUBLIN-GRANVILLE RD COLUMBUS OH 43231
	JOB NO. 15- DATE 1- FILE A2- PLOT SCALE 1:1	-016 11-16 3-1
	OWNER APPRO	VAL
	Dai	.e
]	SHEET TI ENLARGED FLOOR P	THIRD

NORTH


SHEET NUMBER

A2.3.1

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83RD

		RESID	ENT STORAGE				
of Units	Storage Space Required Per IHDA (cu ft)	Storage Space Required Per Tinley Park (cu ft)	Minimum Storage Space Required in Each Unit (cu ft)	Common Area Storage Space Required for Each Unit (cu ft)	Storage Space Provided in Unit (cu ft)	Common Area Storage Space Provided (cu ft)	Total Storage Space Provided (cu ft)
	72	150	50	100	88	218	306
	72	150	50	100	116	218	334
	128	200	67	133	80	218	298
	128	200	67	133	79	218	297
	200	250	84	166	85	218	303
	200	250	84	166	85	218	303



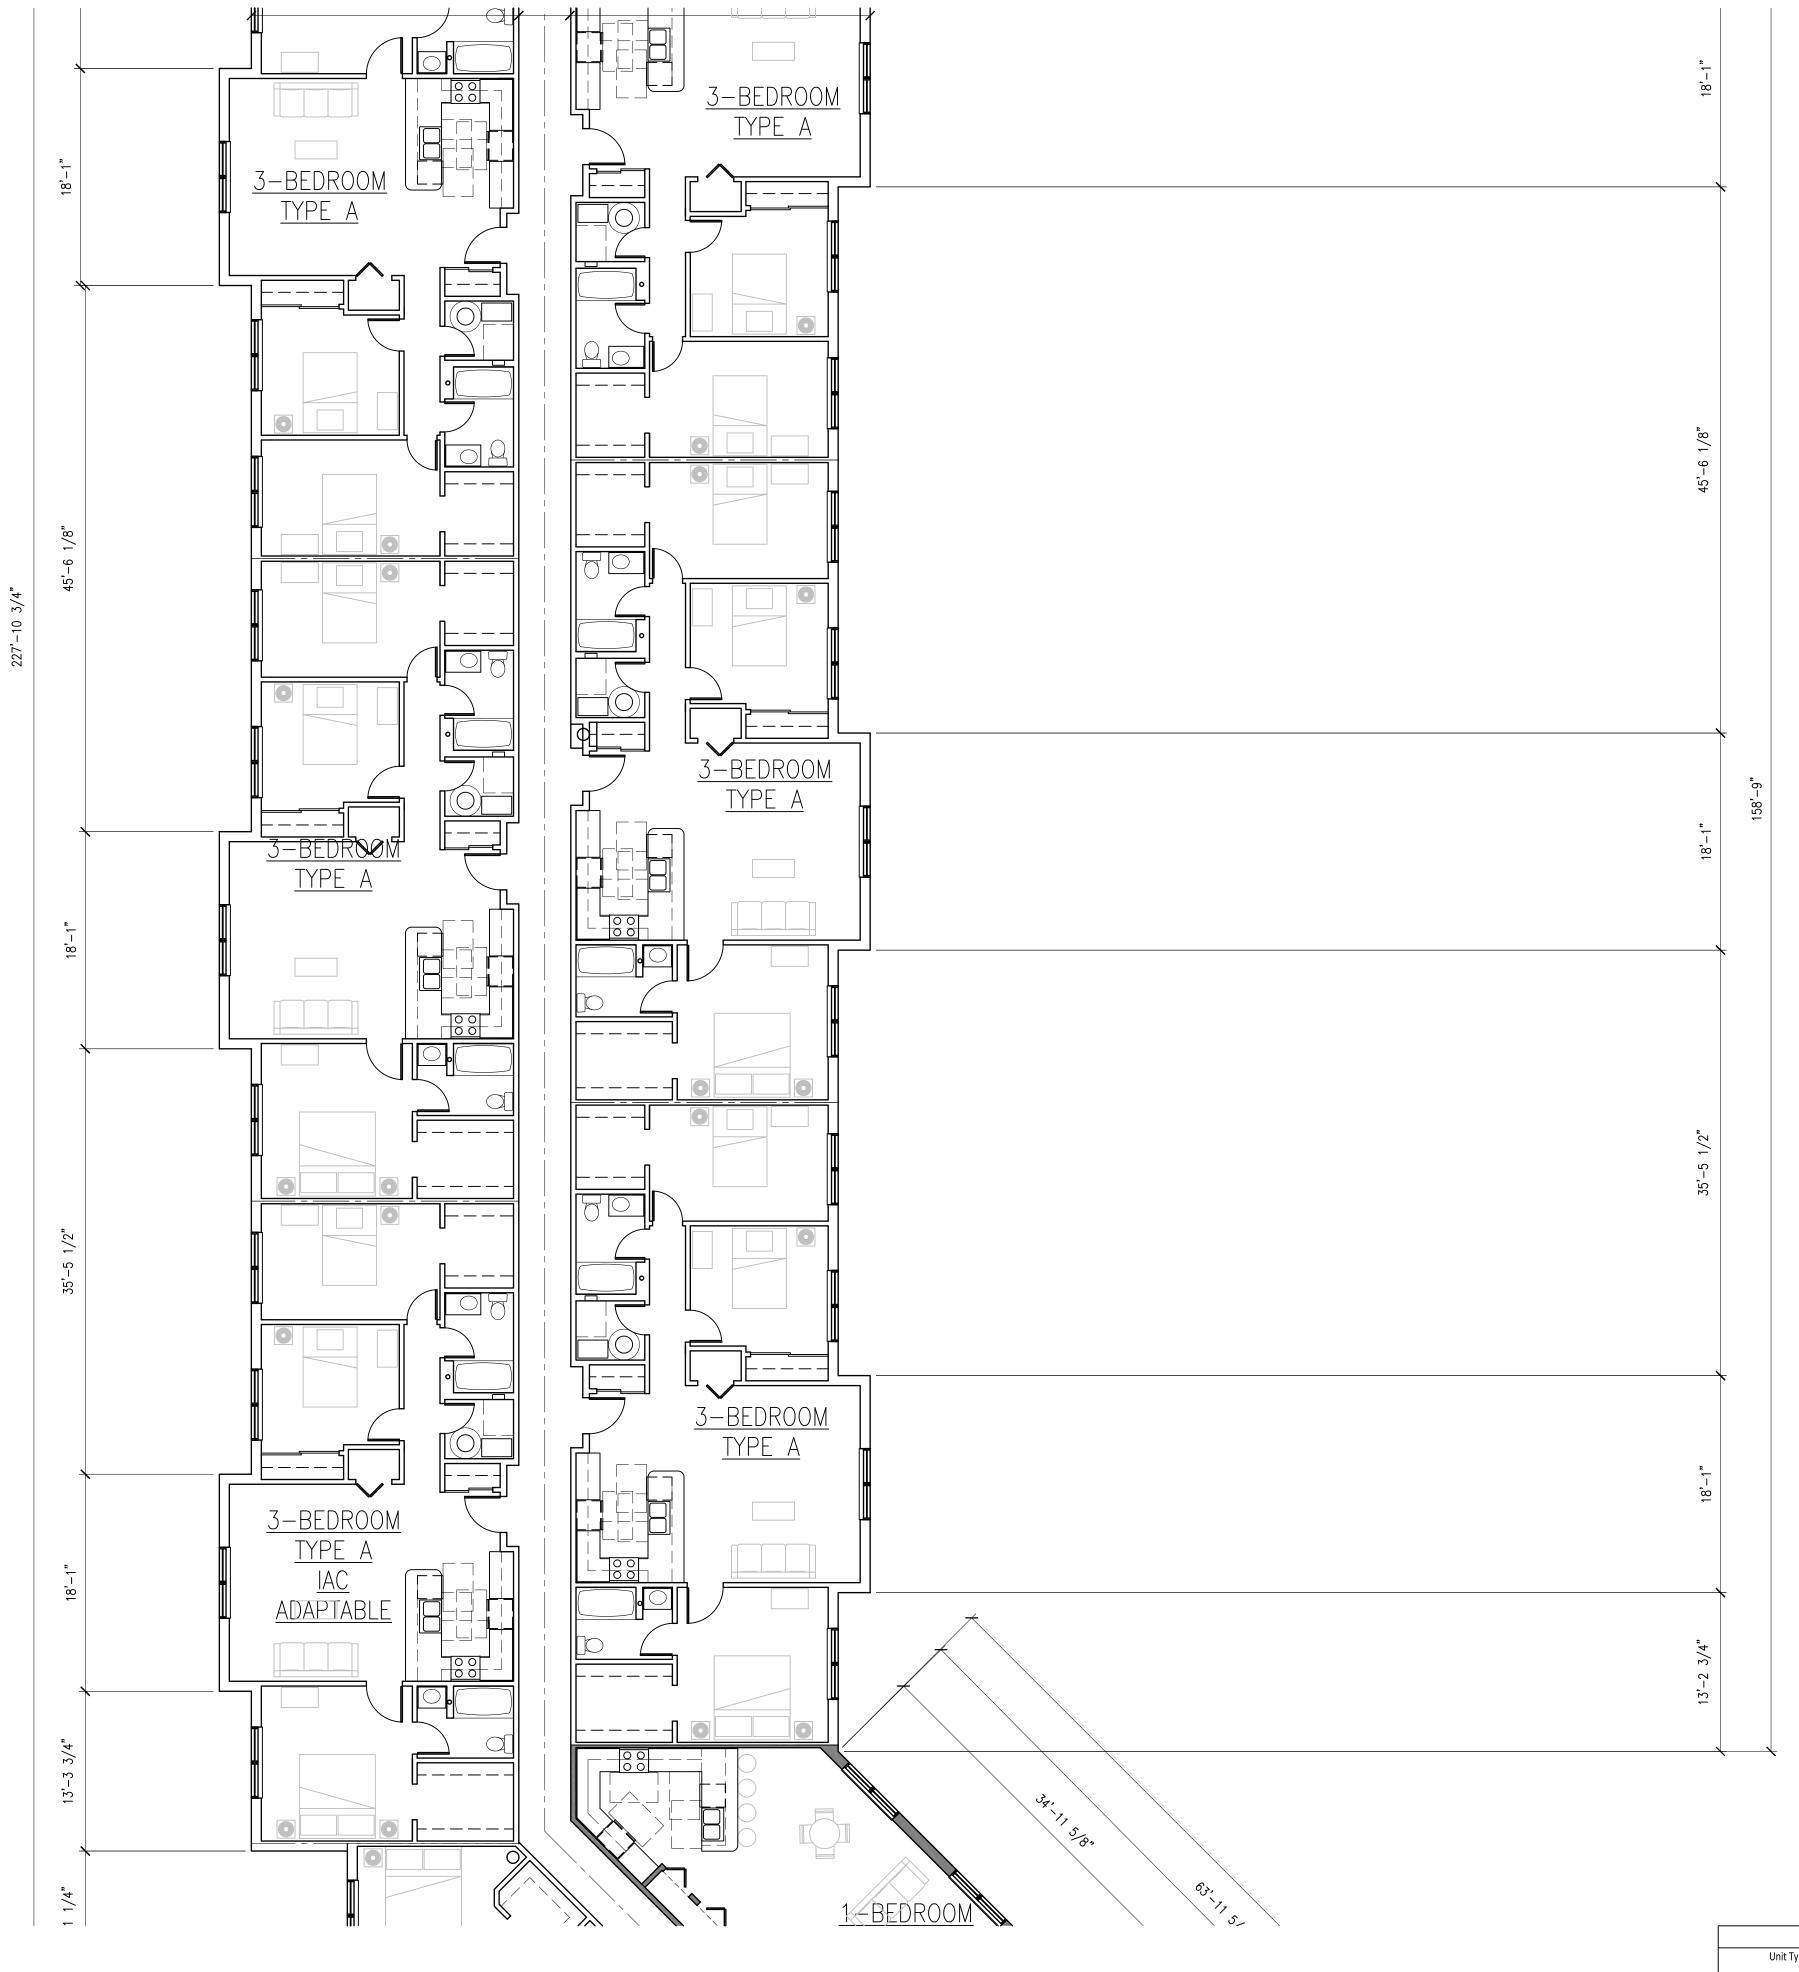

ENLARGED THIRD FLOOR PLAN - NORTH CENTER

Unit Type	Number of
1-Bedroom Type A	6
1-Bedroom Type B	4
2-Bedroom Type A	4
2-Bedroom Type B	6
3-Bedroom Type A	23
3-Bedroom Type B	4
Total	47

- 1. ALL INTERIOR DIMENSIONS ARE TO FACE OF FINISH UNLESS NOTED OTHERWISE
- ALL EXTERIOR DIMENSIONS ARE TO FACE OF FOUNDATION WALL UNLESS NOTED OTHERWISE 2.
- ALL STEEL COLUMNS SHALL RECEIVE SPRAY APPLIED FIREPROOFING UL # X752 1 HOUR 3. RATING
- 4. THE GURNEE SIZED ELEVATOR (INDICATED ON THE PLAN) SHALL BE IDENTIFIED BY THE INTERNATION SYMBOL FOR EMERGENCY MEDICAL SERVICES (STAR OF LIFE). THE SYMBOL SHALL BE NOT LESS THAN THREE INCHES (3") HIGH AND SHALL BE PLACED ON BOTH SIDES OF THE HOIST WAY DOOR FRAME
- THE WATER MAIN SERVING THE FIRE SPRINKLER SYSTEM TO BE FLUSHED AT A RATE 5. APPRPRIATE TO ITS SIZE, PRIOR TO CONNECTION TO THE SYSTEM. NOTIFY THE LOCAL AUTHORITY TWENTY-FOUR HOURS (24) IN ADVANCE OF THE FLUSHING TO WITNESS.
- PROVIDE AN APPROVED PICTORAL SIGN OF A STANDARDIZED DESIGN SHALL BE POSTED 6. ADJACENT TO EACH ELEVATOR CALL STATION ON ALL FLOORS INSTRUCTING OCCUPANTS TO USE THE EXIT STAIRWAYS AND NOT TO USE THE ELEVATOR IN CASE OF FIRE. THE SIGN SHALL READ: "IN FIRE EMERGENCY, DO NOT USE ELEVATOR, USE EXIT STAIRS."
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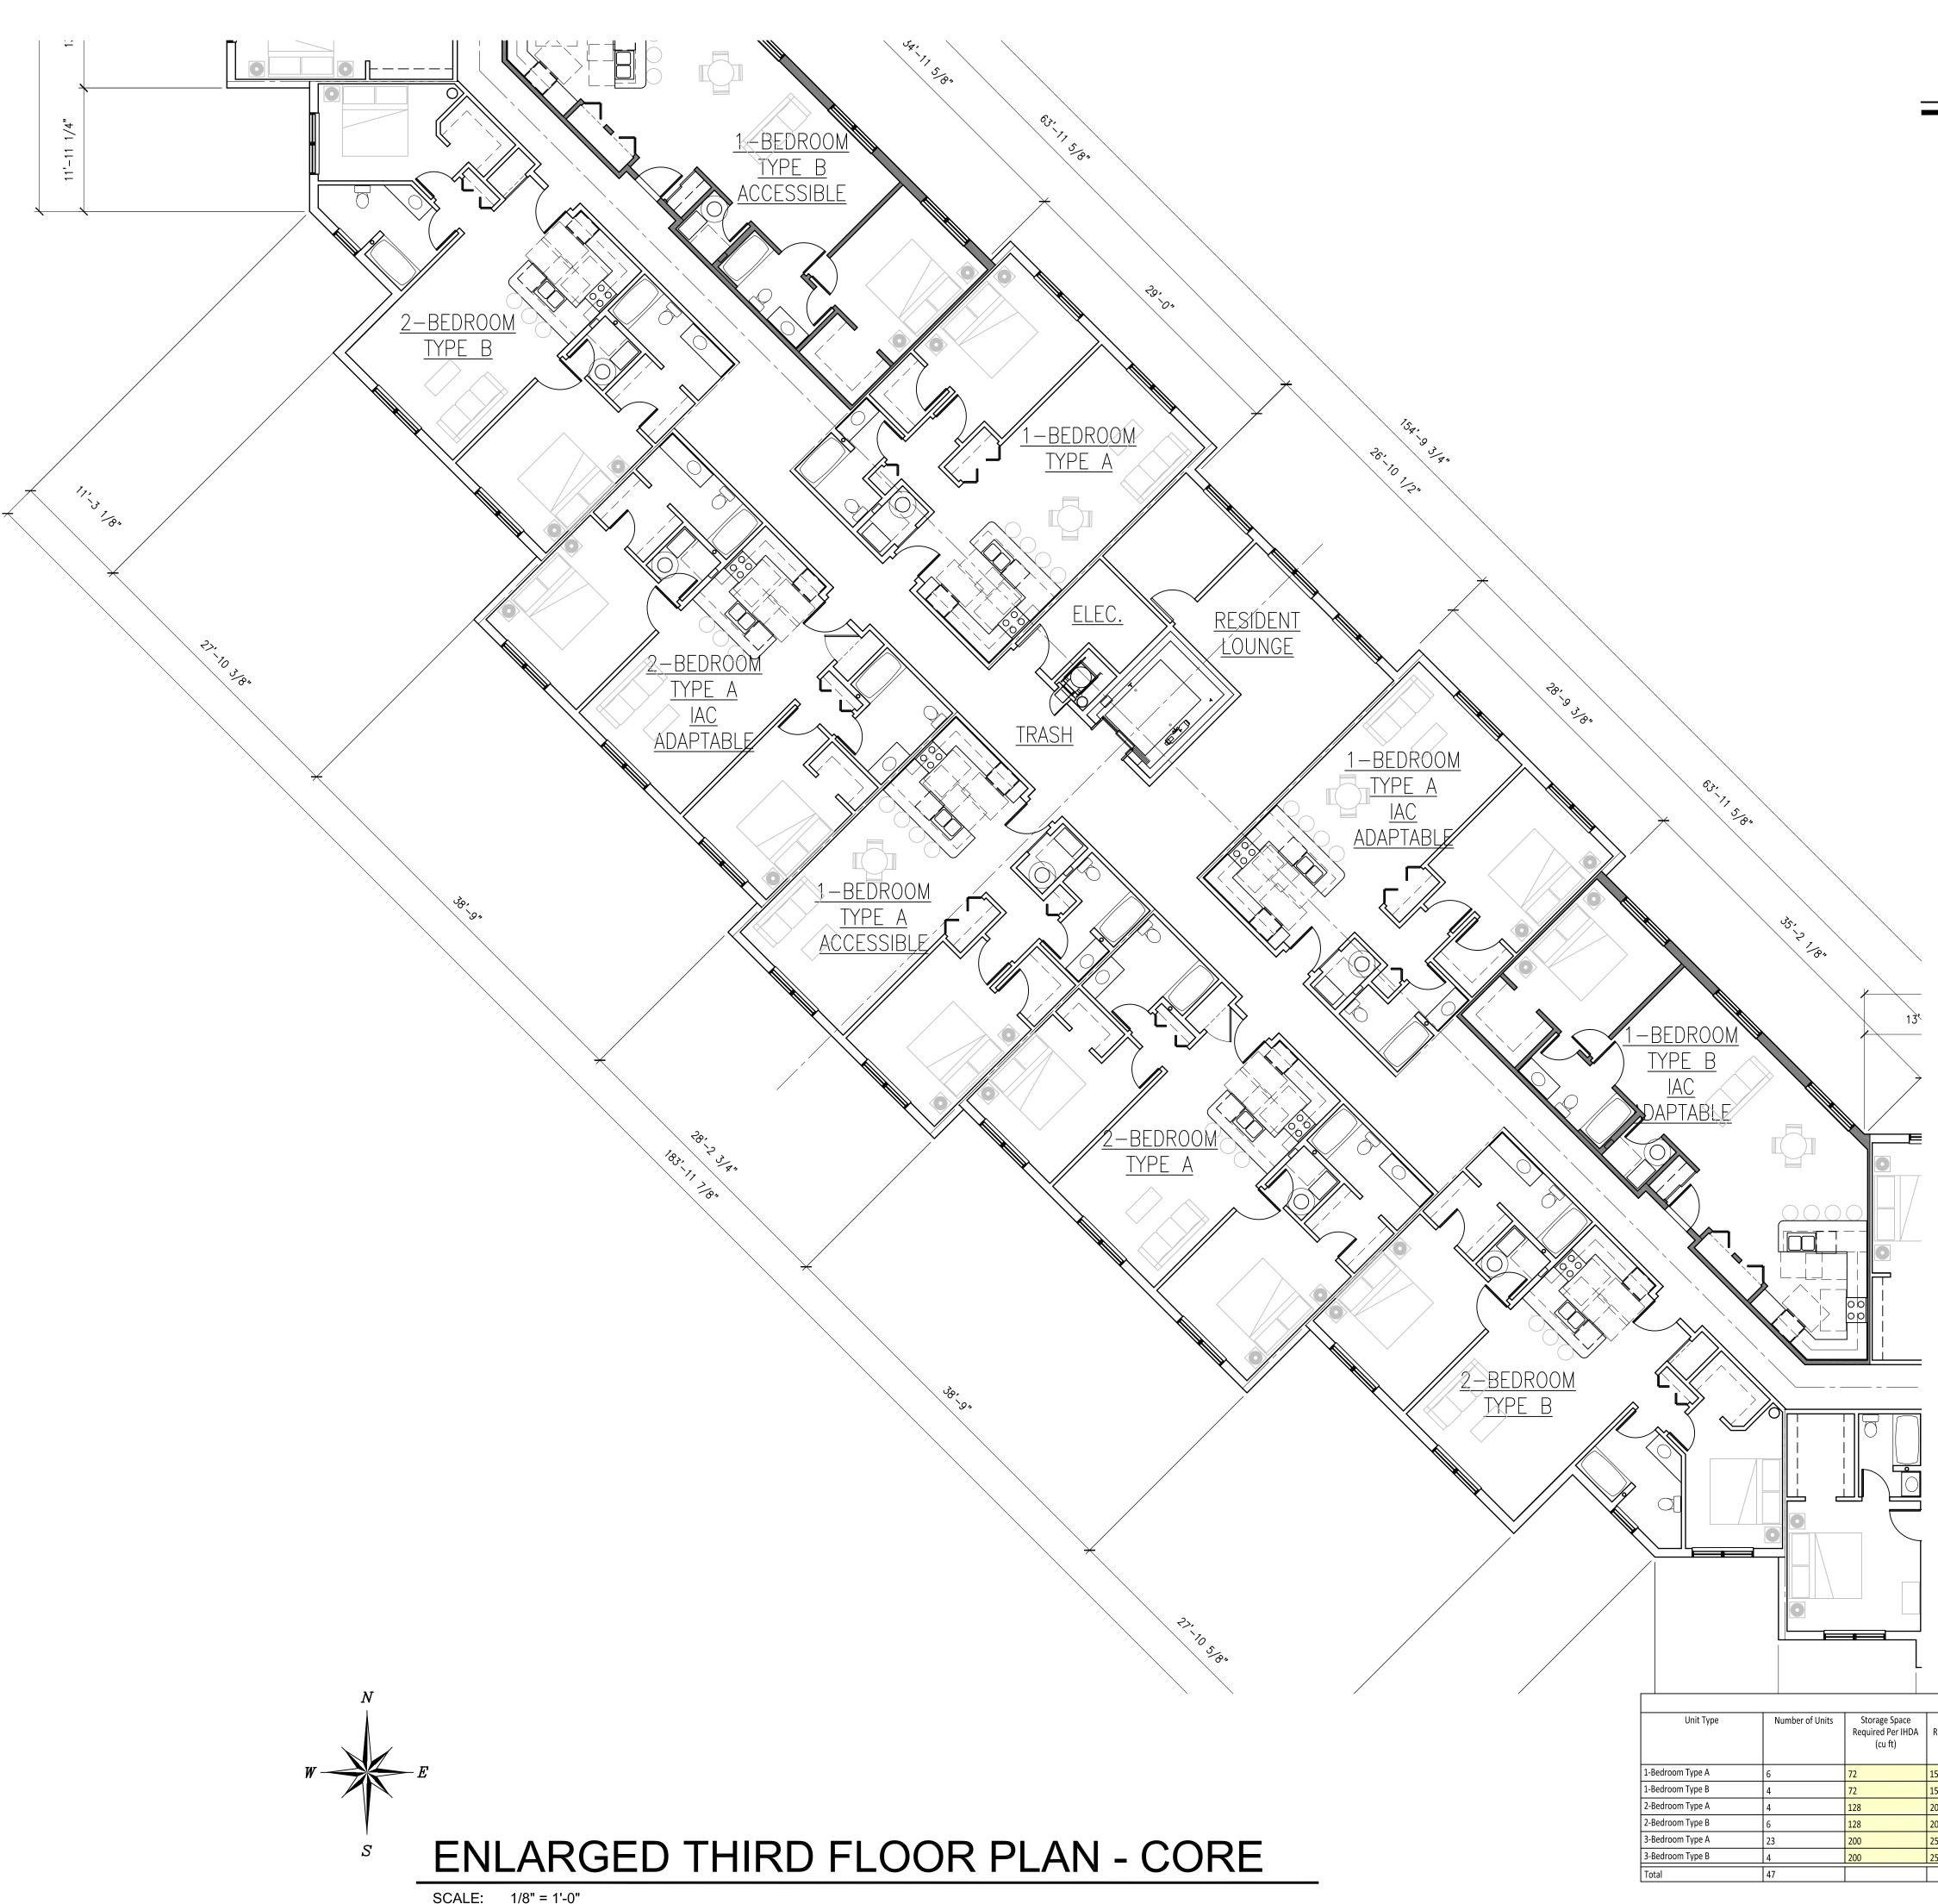
		UNIT SL	IMMARY		
Floor	Unit Type	FHA Adaptable	Sensory Impared	IAC Adaptable	IAC Accessible
	1-Bed Type A	0	0	0	0
	1-Bed Type B	0	0	0	0
	2-Bed Type A	0	0	0	0
1st Floor	2-Bed Type B	2	0	1	1
	3-Bed Type A	5	1	1	1
	3-Bed Type B	0	0	0	0
	Totals	7	1	2	2
	1-Bed Type A	3	0	1	1
	1-Bed Type B	2	0	1	1
	2-Bed Type A	2	0	1	0
2nd Floor	2-Bed Type B	2	0	0	0
	3-Bed Type A	9	0	1	0
	3-Bed Type B	2	0	0	0
	Totals	20	0	4	2
	1-Bed Type A	3	0	1	0
	1-Bed Type B	2	0	1	0
	2-Bed Type A	2	0	1	1
3rd Floor	2-Bed Type B	2	0	1	0
	3-Bed Type A	9	0	1	0
	3-Bed Type B	2	0	0	0
	Totals	20	0	5	1
	1-Bed Type A	6	0	2	1
	1-Bed Type B	4	0	2	1
	2-Bed Type A	4	0	2	1
Total Project	2-Bed Type B	6	0	2	1
rotarrioject	3-Bed Type A	23	1	3	1
	3-Bed Type B	4	0	0	0
	Totals	47	1	11	5
	%	100%	2%	23%	11%

PROJECT: THE RESERVE AT TINLEY PARK NORTHEAST CORNER OF OAK PARK AVENUE AND 183RD ST TINLEY PARK, IL	CLIENT: BUCKEYE COMMUNITY HOPE FOUNDATION 3021 EAST DUBLIN-GRANVILLE RD COLUMBUS OH 43231
DATE 1	
Signature	Date
SHEET T ENLARGE FLOOR	D THIRD

		RESID	ENT STORAGE				
its	Storage Space Required Per IHDA (cu ft)	Storage Space Required Per Tinley Park (cu ft)	Minimum Storage Space Required in Each Unit (cu ft)	Common Area Storage Space Required for Each Unit (cu ft)	Storage Space Provided in Unit (cu ft)	Common Area Storage Space Provided (cu ft)	Total Storage Space Provided (cu ft)
	72	150	50	100	88	218	306
	72	150	50	100	116	218	334
	128	200	67	133	80	218	298
	128	200	67	133	79	218	297
	200	250	84	166	85	218	303
	200	250	84	166	85	218	303



NORTH CENTER






- 1. ALL INTERIOR DIMENSIONS ARE TO FACE OF FINISH UNLESS NOTED OTHERWISE
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- ALL STEEL COLUMNS SHALL RECEIVE SPRAY APPLIED FIREPROOFING UL # X752 1 HOUR 3. RATING
- 4. THE GURNEE SIZED ELEVATOR (INDICATED ON THE PLAN) SHALL BE IDENTIFIED BY THE INTERNATION SYMBOL FOR EMERGENCY MEDICAL SERVICES (STAR OF LIFE). THE SYMBOL SHALL BE NOT LESS THAN THREE INCHES (3") HIGH AND SHALL BE PLACED ON BOTH SIDES OF THE HOIST WAY DOOR FRAME
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- 9. PROVIDE SIGNAGE ON DOORS OF ALL ELECTRICAL ROOMS CONTAINING CONTROL PANELS STATING: "ELECTRICAL ROOM". REFER TO SHEET A10.4



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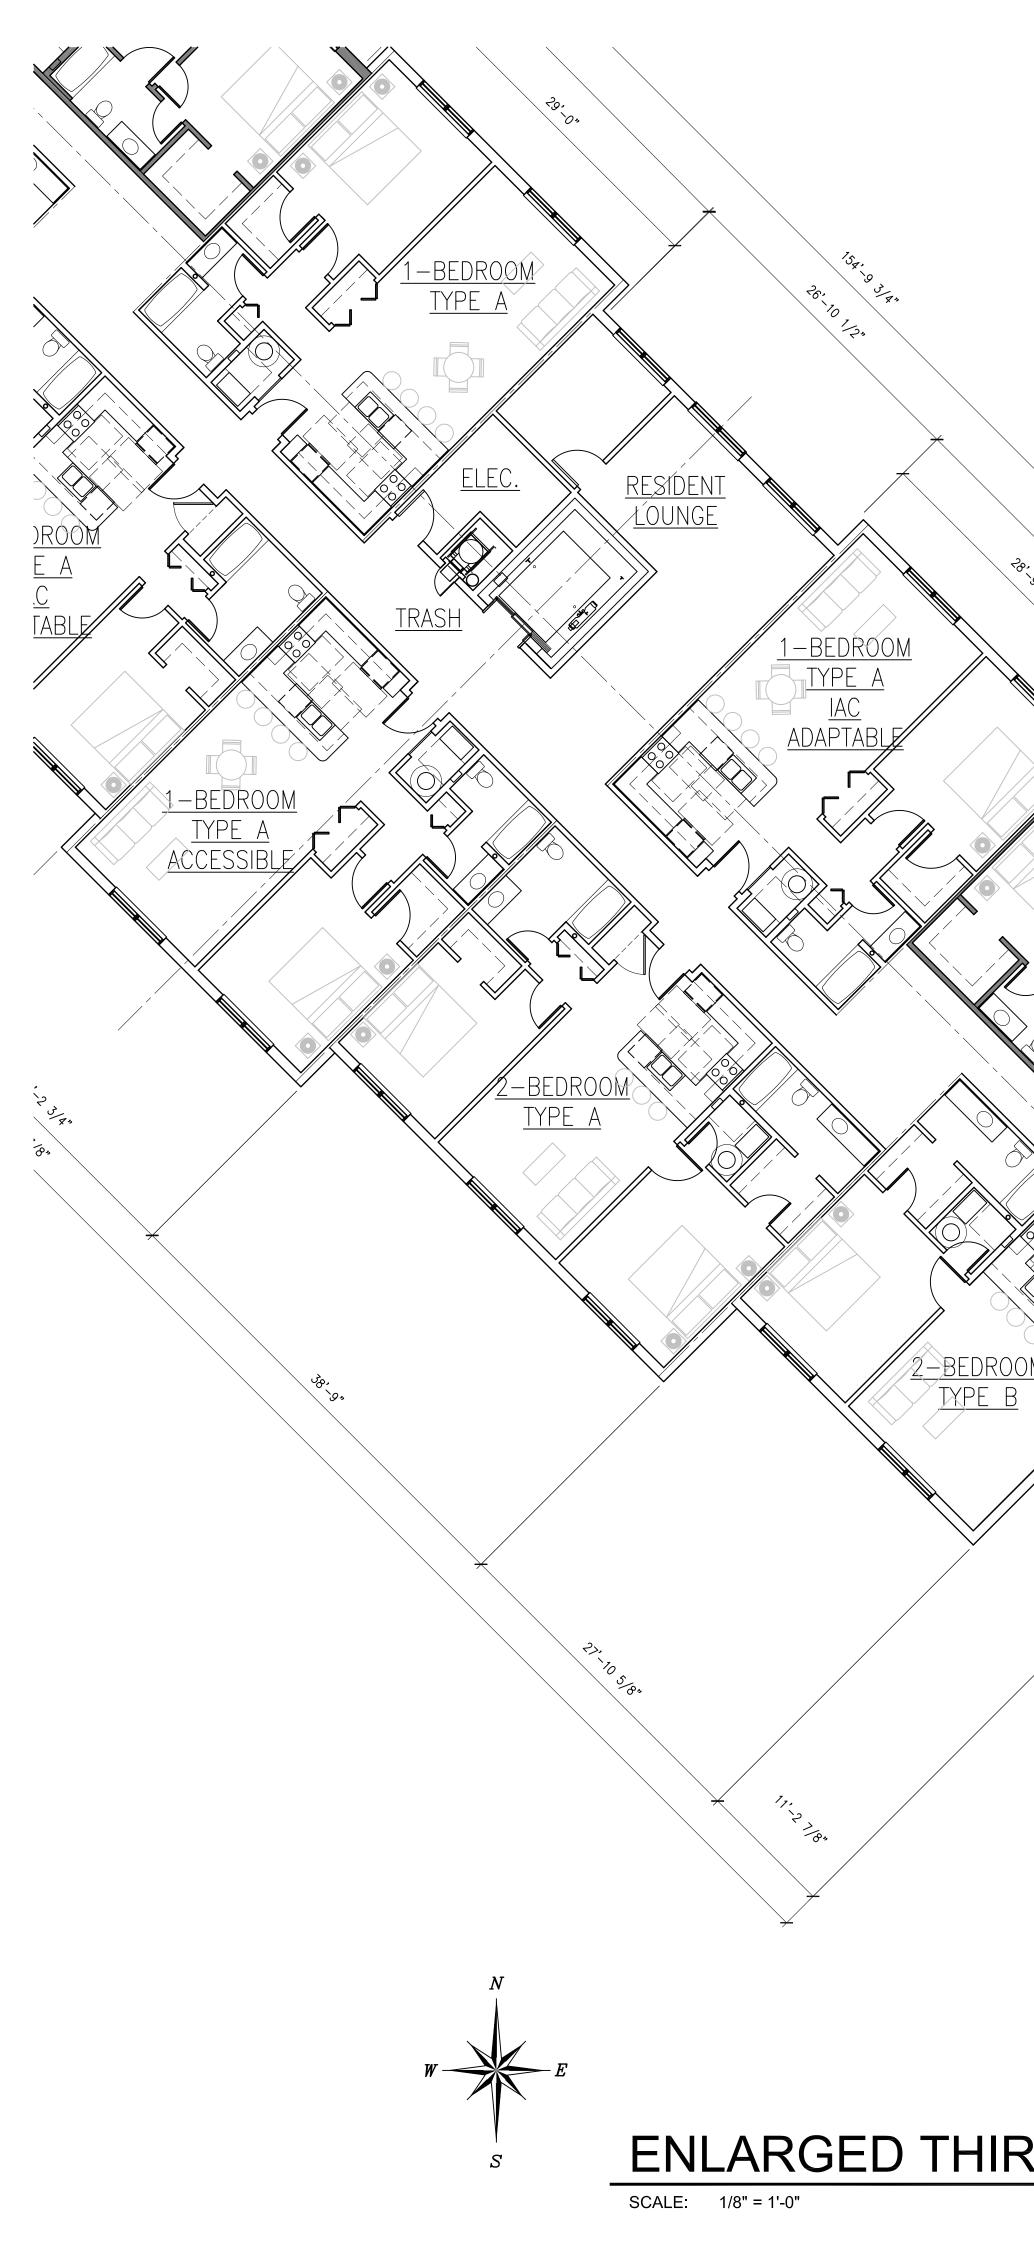
		UNIT SU	MMARY		
Floor	Unit Type	FHA Adaptable	Sensory Impared	IAC Adaptable	IAC Accessible
	1-Bed Type A	0	0	0	0
	1-Bed Type B	0	0	0	0
	2-Bed Type A	0	0	0	0
1st Floor	2-Bed Type B	2	0	1	1
	3-Bed Type A	5	1	1	1
	3-Bed Type B	0	0	0	0
	Totals	7	1	2	2
			•		
	1-Bed Type A	3	0	1	1
	1-Bed Type B	2	0	1	1
	2-Bed Type A	2	0	1	0
2nd Floor	2-Bed Type B	2	0	0	0
	3-Bed Type A	9	0	1	0
	3-Bed Type B	2	0	0	0
	Totals	20	0	4	2
	1-Bed Type A	3	0	1	0
	1-Bed Type B	2	0	1	0
	2-Bed Type A	2	0	1	1
3rd Floor	2-Bed Type B	2	0	1	0
	3-Bed Type A	9	0	1	0
	3-Bed Type B	2	0	0	0
	Totals	20	0	5	1
	1-Bed Type A	6	0	2	1
	1-Bed Type B	4	0	2	1
	2-Bed Type A	4	0	2	1
Total Project	2-Bed Type B	6	0	2	1
rotar Project	3-Bed Type A	23	1	3	1
	3-Bed Type B	4	0	0	0
	Totals	47	1	11	5
	%	100%	2%	23%	11%

		lotals	4/	1	11	5	
		%	100%	2%	23%	11%	
-							-
	RESID	DENT STORAGE					
Requi	orage Space red Per Tinley ark (cu ft)	Minimum Storage Space Required in Each Unit (cu ft)	Common Area Storage Space Required for Each Unit (cu ft)	Storage Space Provided in Unit (cu ft)	Common Are Storage Space Provided (cu	ce Provided (
150		50	100	88	218	306	
150		50	100	116	218	334	
200		67	133	80	218	298	
200		67	133	79	218	297	
250		84	166	85	218	303	
250		84	166	85	218	303	

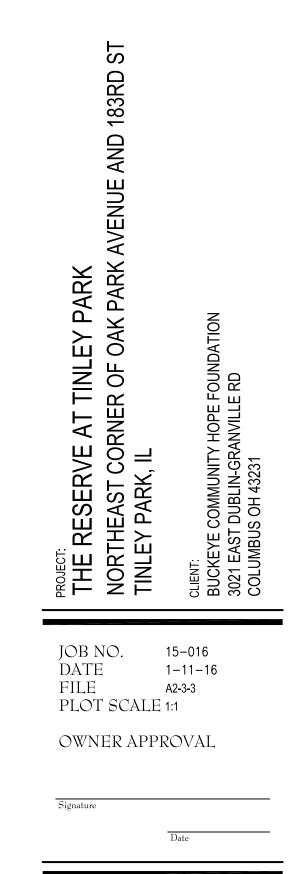

SHEET TITLE ENLARGED THIRD FLOOR PLAN CORE

sheet number A2.3.3



ેંગ્ર 63. 17 5-61 55'-3 3/8" 17'-8 7/8" 23'-11 5/8" 13'~6 3/4" >> BEDROC <u>IAC</u> <u>3-BEDROOM</u> TYPE B Ń <u>3-BEDROOM</u> 11'-11 1/4" 13'-3 3/4" 32'-2 1/2" 18'-1" 75'-6 1/2"

Unit Type	Number of Units
1-Bedroom Type A	6
1-Bedroom Type B	4
2-Bedroom Type A	4
2-Bedroom Type B	6
3-Bedroom Type A	23
3-Bedroom Type B	4
Total	47

ENLARGED THIRD FLOOR PLAN - EAST

- 1. ALL INTERIOR DIMENSIONS ARE TO FACE OF FINISH UNLESS NOTED OTHERWISE
- 2. ALL EXTERIOR DIMENSIONS ARE TO FACE OF FOUNDATION WALL UNLESS NOTED OTHERWISE
- 3. ALL STEEL COLUMNS SHALL RECEIVE SPRAY APPLIED FIREPROOFING UL # X752 1 HOUR RATING
- 4. THE GURNEE SIZED ELEVATOR (INDICATED ON THE PLAN) SHALL BE IDENTIFIED BY THE INTERNATION SYMBOL FOR EMERGENCY MEDICAL SERVICES (STAR OF LIFE). THE SYMBOL SHALL BE NOT LESS THAN THREE INCHES (3") HIGH AND SHALL BE PLACED ON BOTH SIDES OF THE HOIST WAY DOOR FRAME
- 5. THE WATER MAIN SERVING THE FIRE SPRINKLER SYSTEM TO BE FLUSHED AT A RATE APPRPRIATE TO ITS SIZE, PRIOR TO CONNECTION TO THE SYSTEM. NOTIFY THE LOCAL AUTHORITY TWENTY-FOUR HOURS (24) IN ADVANCE OF THE FLUSHING TO WITNESS.
- 6. PROVIDE AN APPROVED PICTORAL SIGN OF A STANDARDIZED DESIGN SHALL BE POSTED ADJACENT TO EACH ELEVATOR CALL STATION ON ALL FLOORS INSTRUCTING OCCUPANTS TO USE THE EXIT STAIRWAYS AND NOT TO USE THE ELEVATOR IN CASE OF FIRE. THE SIGN SHALL READ: "IN FIRE EMERGENCY, DO NOT USE ELEVATOR, USE EXIT STAIRS."
- 7. PROVIDE A KEY BOX IF REQUIRED BY THE LOCAL AUTHORITY. VERIFY WITH THE AHJ THE DEVICE REQUIREMENTS AND LOCATION
- 8. ROOMS CONTAINING CONTROLS FOR AIR-CONDITIONING SYSTEMS, SPRINKLER RISERS, AND VALVES, OR OTHER FIRE DETECTION, SUPPRESSION, OR CONTROL ELEMENTS SHALL BE IDENTIFIED WITH SIGNAGE OF DURABLE MATERIALS, PERMANENTLY INSTALLED, AND READILY VISIBLE.
- 9. PROVIDE SIGNAGE ON DOORS OF ALL ELECTRICAL ROOMS CONTAINING CONTROL PANELS STATING: "ELECTRICAL ROOM". REFER TO SHEET A10.4



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<u>Flag</u>	Unit Type	FHA Adaptable	Sensory Impared	IAC Adaptable	
Floor	1-Bed Type A				IAC Accessible
	1-Bed Type A	0	0	0	0
	2-Bed Type A	0	0	0	0
1st Floor	2-Bed Type A 2-Bed Type B	2	0	1	1
13111001	3-Bed Type A	5	1	1	1
	3-Bed Type B	0	0	0	0
	Totals	7	1	2	2
		/	 [⊥]	<u> </u>	-
	1-Bed Type A	3	0	1	1
	1-Bed Type B	2	0	1	1
	2-Bed Type A	2	0	1	0
2nd Floor	2-Bed Type B	2	0	0	0
	3-Bed Type A	9	0	1	0
	3-Bed Type B	2	0	0	0
	Totals	20	0	4	2
					-
	1-Bed Type A	3	0	1	0
	1-Bed Type B	2	0	1	0
	2-Bed Type A	2	0	1	1
Brd Floor	2-Bed Type B	2	0	1	0
	3-Bed Type A	9	0	1	0
	3-Bed Type B	2	0	0	0
	Totals	20	0	5	1
		•			
	1-Bed Type A	6	0	2	1
	1-Bed Type B	4	0	2	1
	2-Bed Type A	4	0	2	1
tal Project	2-Bed Type B	6	0	2	1
an nojett	3-Bed Type A	23	1	3	1
	3-Bed Type B	4	0	0	0
	Totals	47	1	11	5
	%	100%	2%	23%	11%


PROJECT: THE RESERVE AT TINLEY PARK NORTHEAST CORNER OF OAK PARK AVENUE AND 1 TINLEY PARK, IL	CLIENT: BUCKEYE COMMUNITY HOPE FOUNDATION 3021 EAST DUBLIN-GRANVILLE RD COLUMBUS OH 43231
	15–016 1–11–16 A2-3-4 1:1 ROVAL
Signature	Date
SHEET ENLARGE FLOOR EA	ED THIRD PLAN


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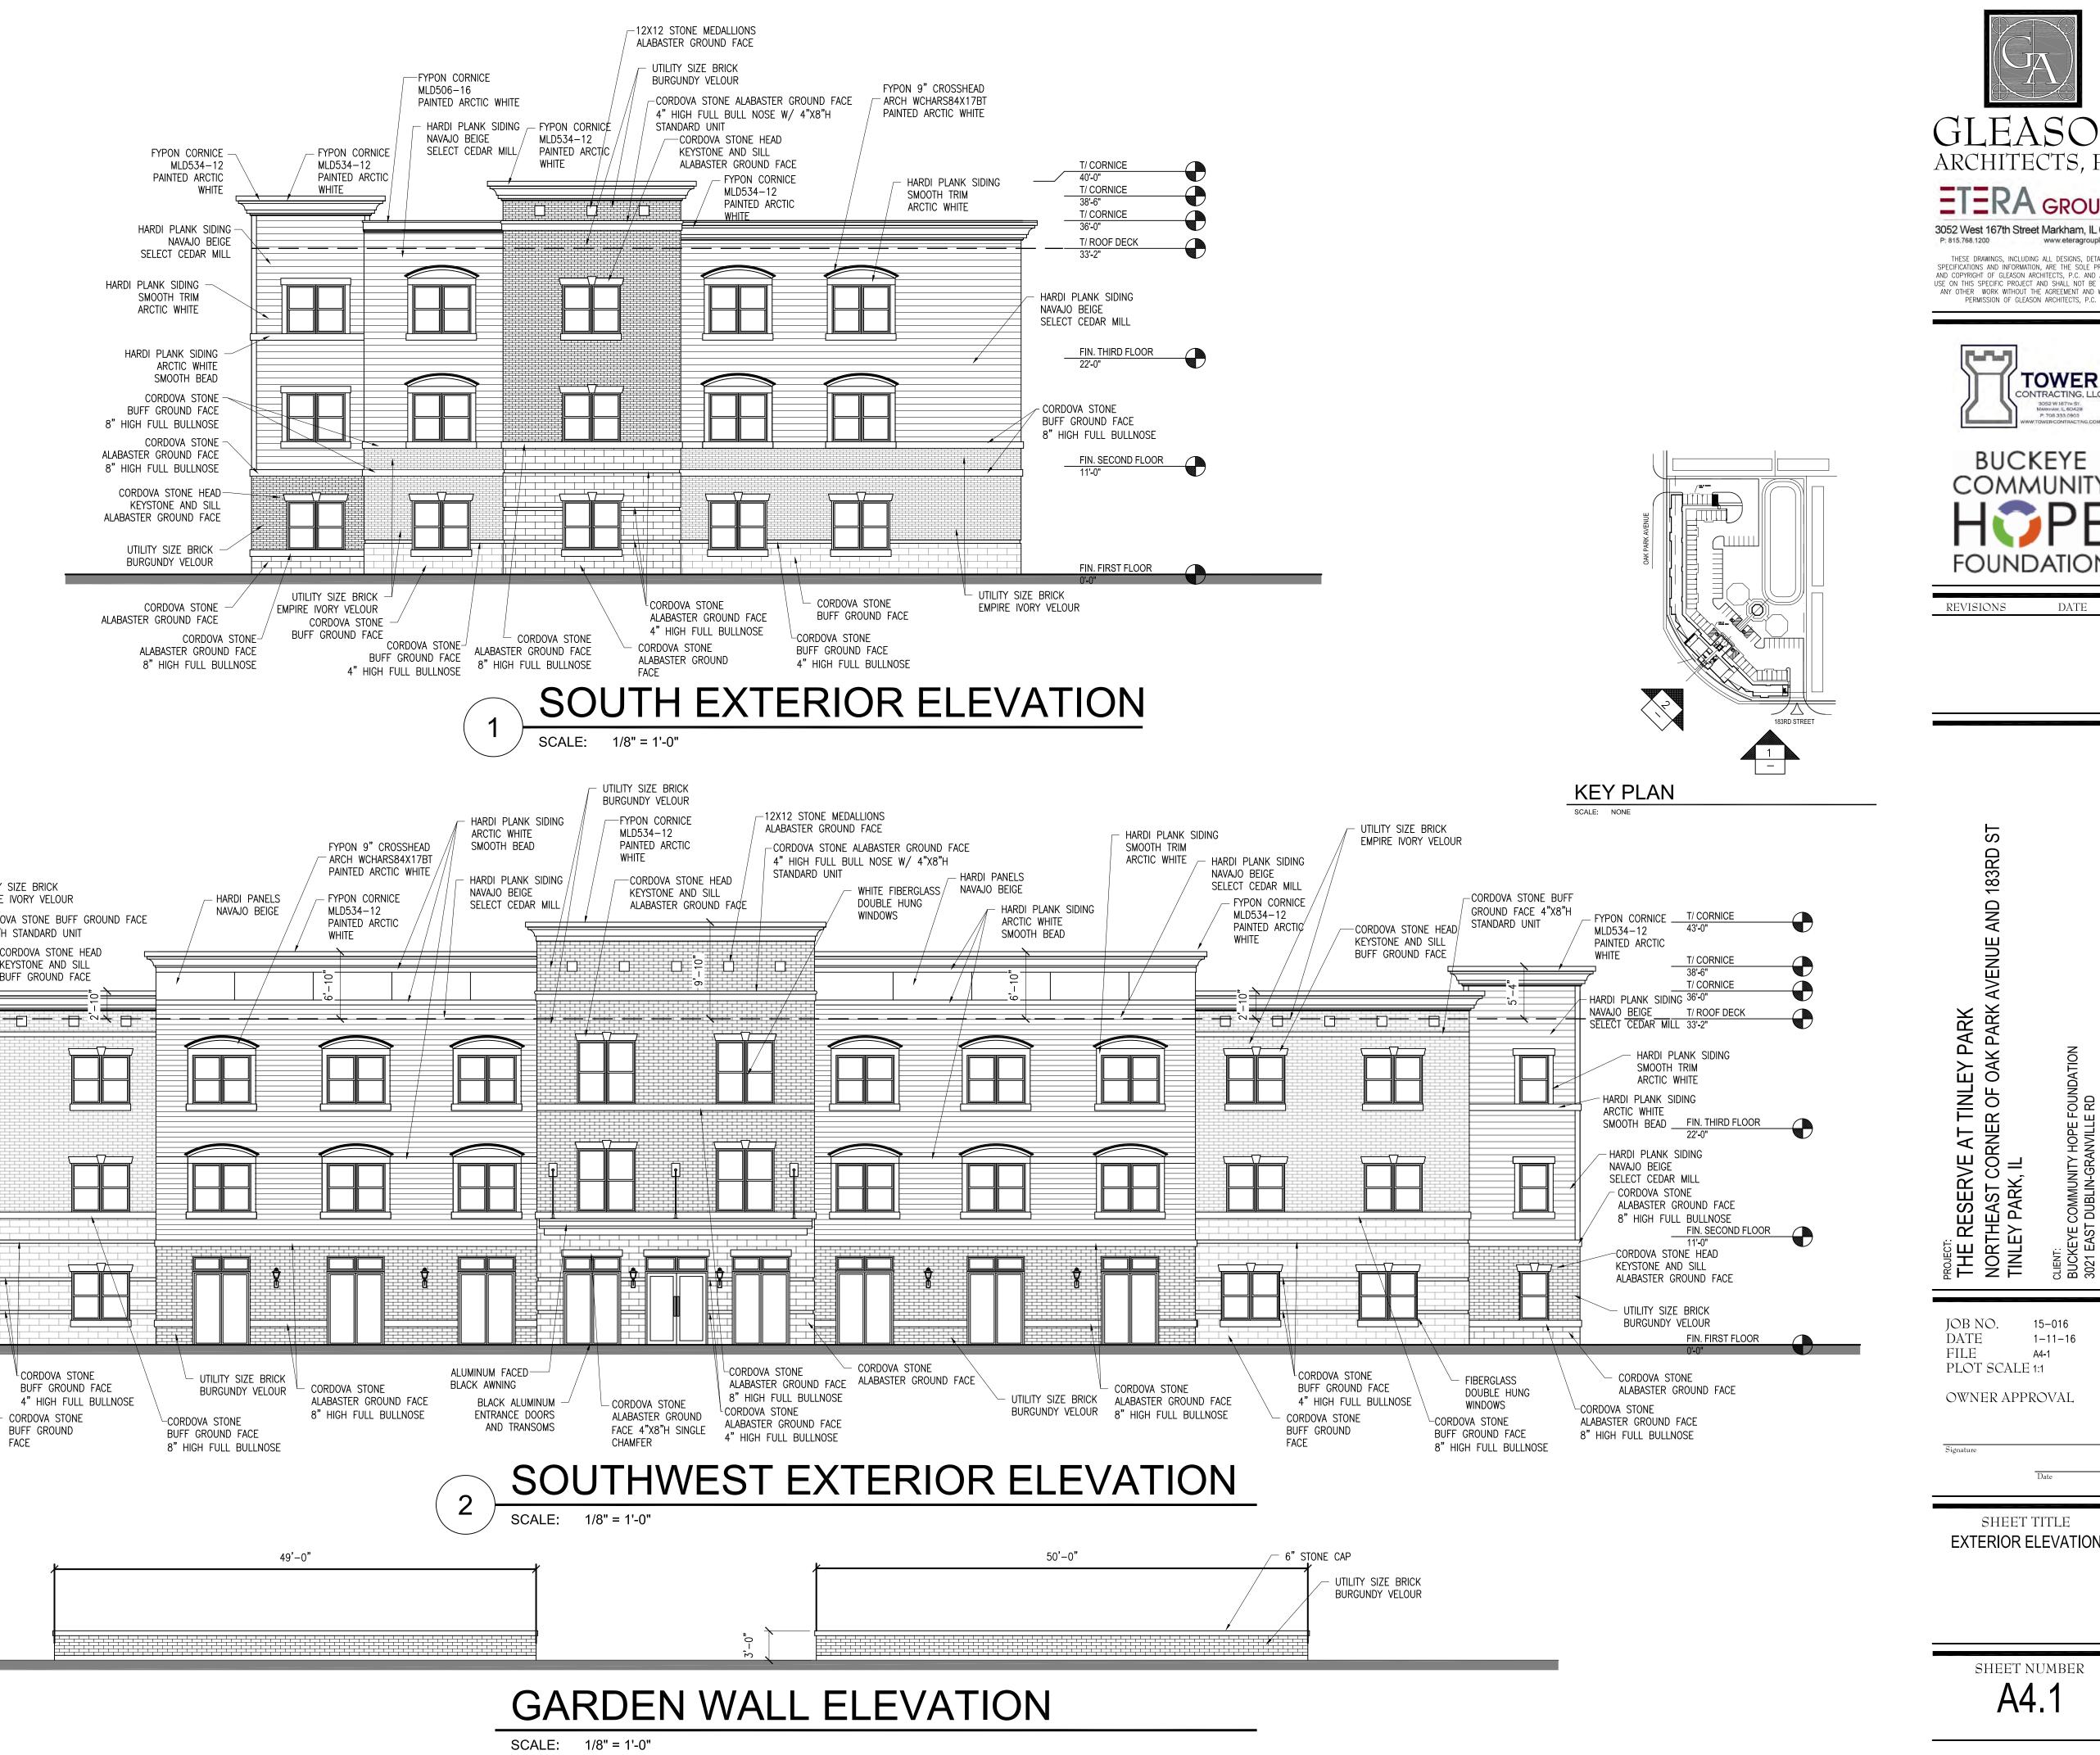
RD


	RESIDENT STORAGE						
:S	Storage Space Required Per IHDA (cu ft)	Storage Space Required Per Tinley Park (cu ft)	Minimum Storage Space Required in Each Unit (cu ft)	Common Area Storage Space Required for Each Unit (cu ft)	Storage Space Provided in Unit (cu ft)	Common Area Storage Space Provided (cu ft)	Total Storage Space Provided (cu ft)
	72	150	50	100	88	218	306
	72	150	50	100	116	218	334
	128	200	67	133	80	218	298
	128	200	67	133	79	218	297
	200	250	84	166	85	218	303
	200	250	84	166	85	218	303

sheet number A2.3.4



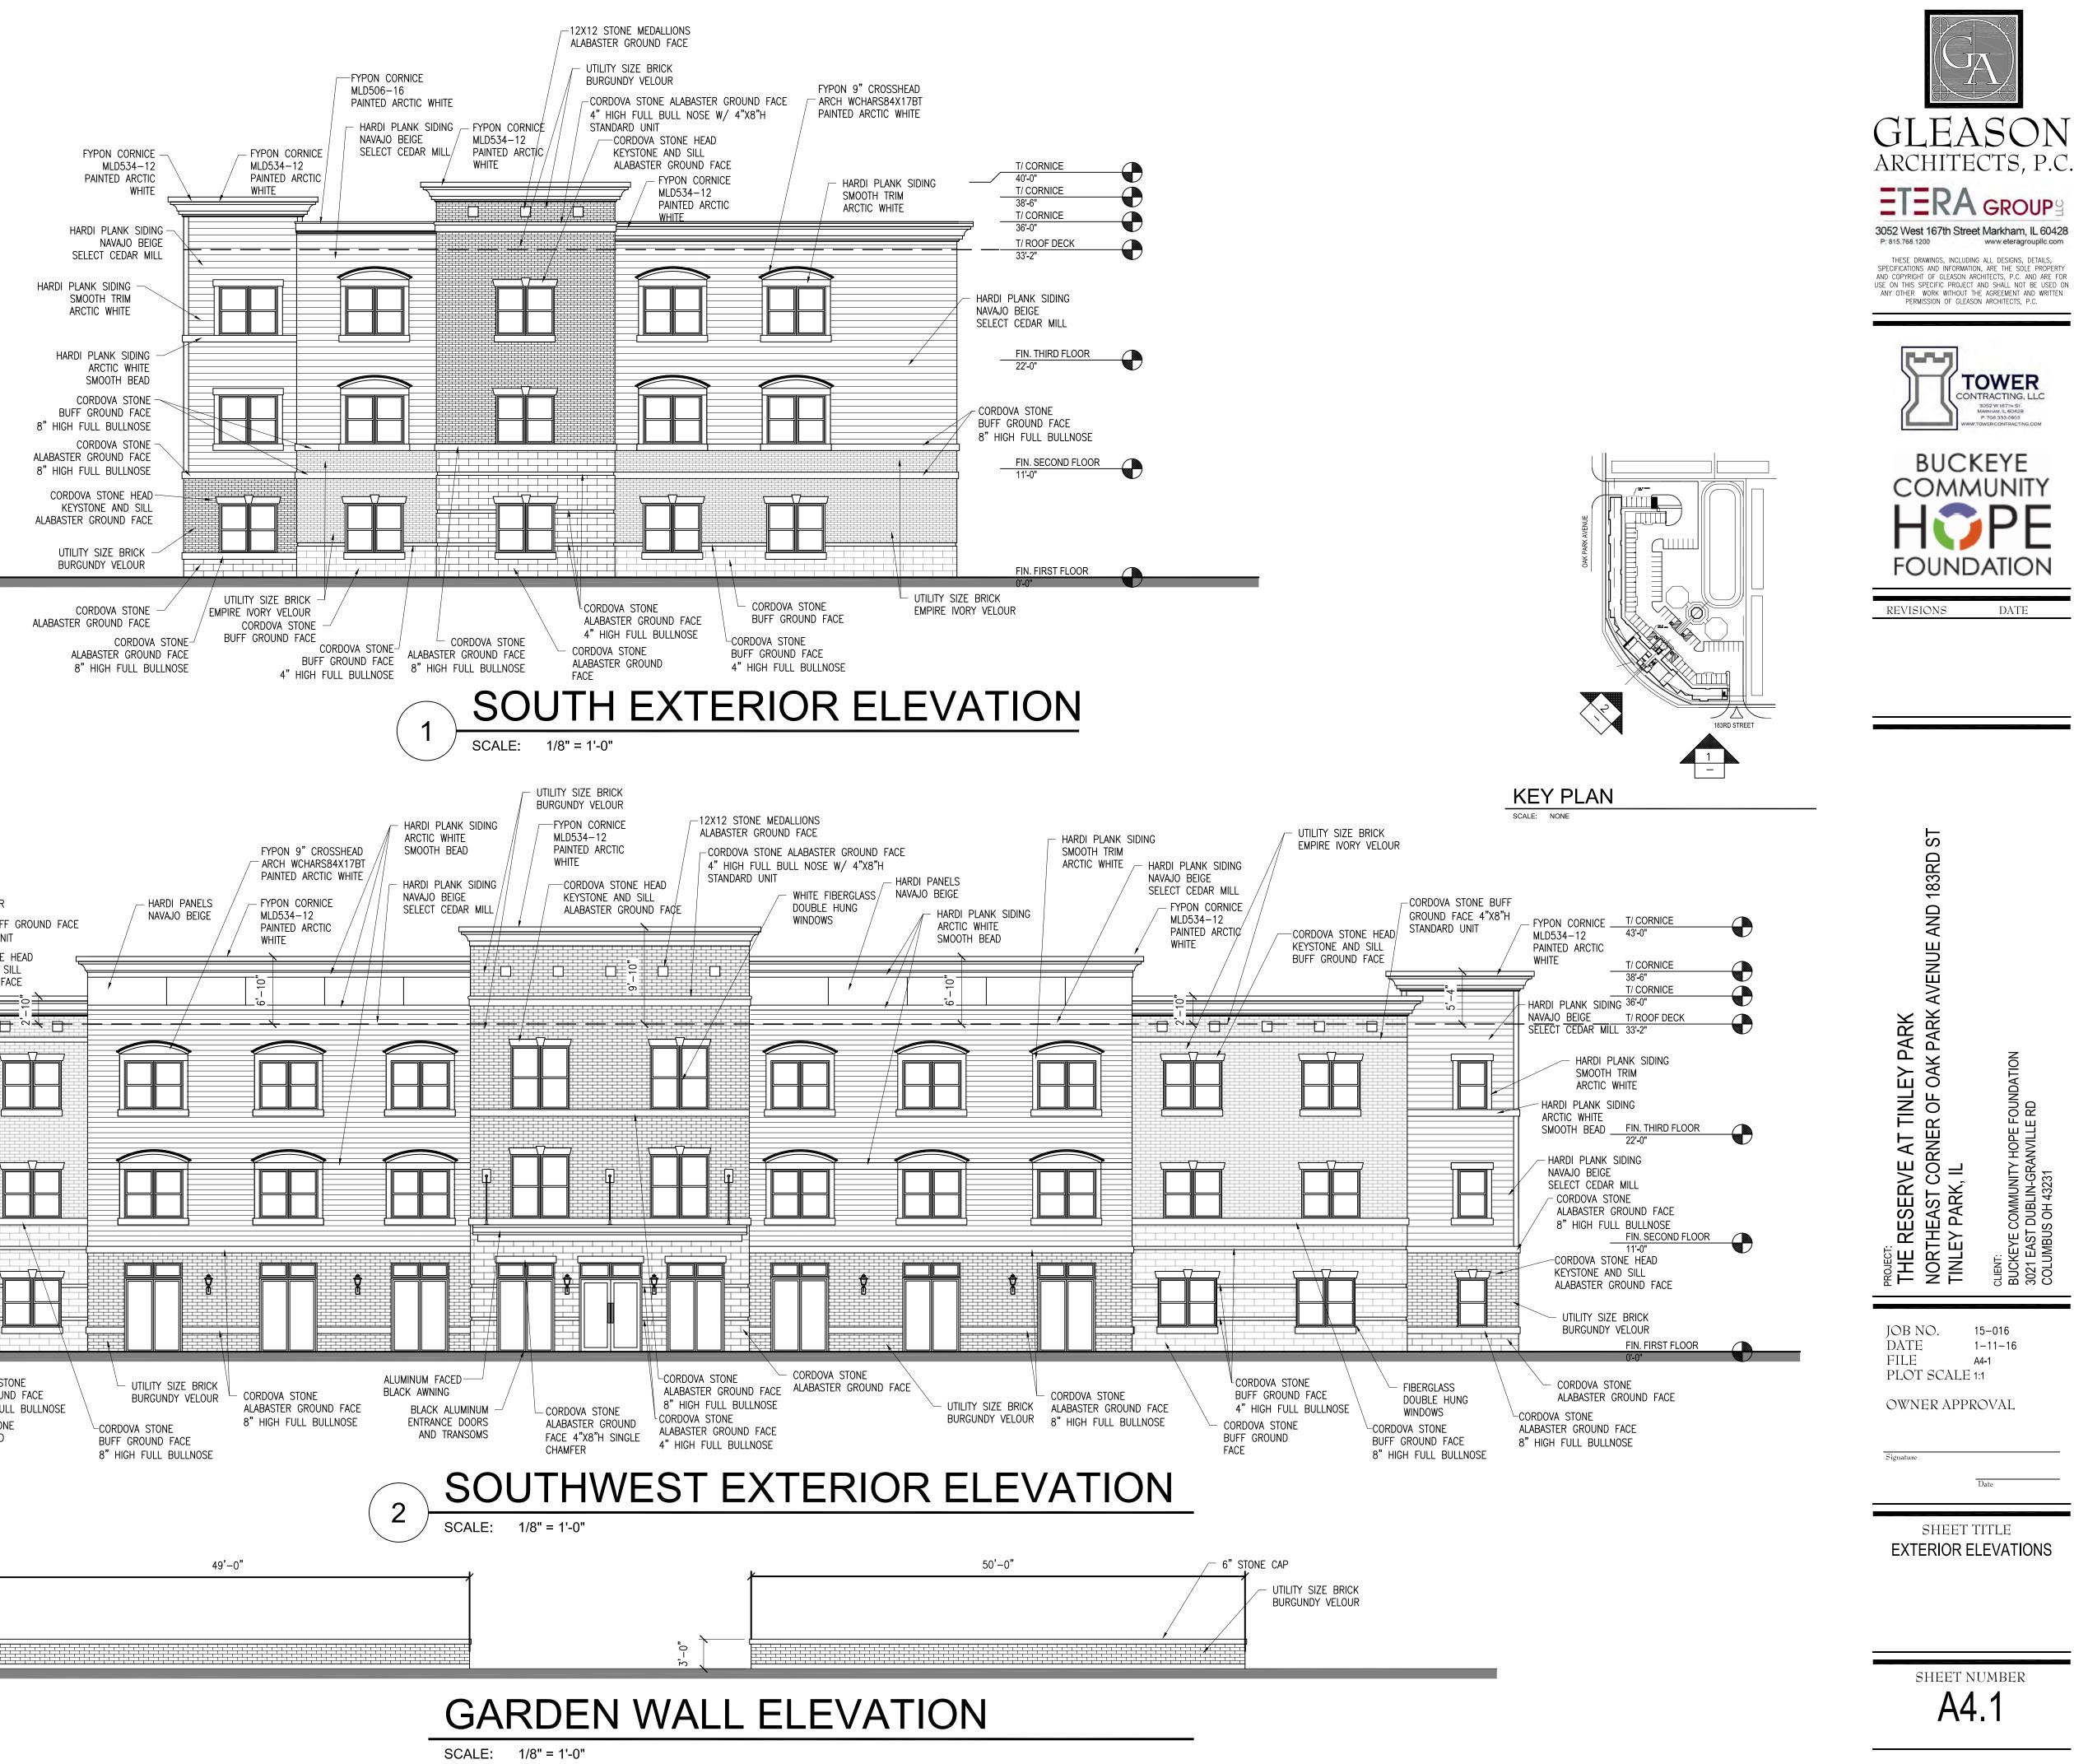

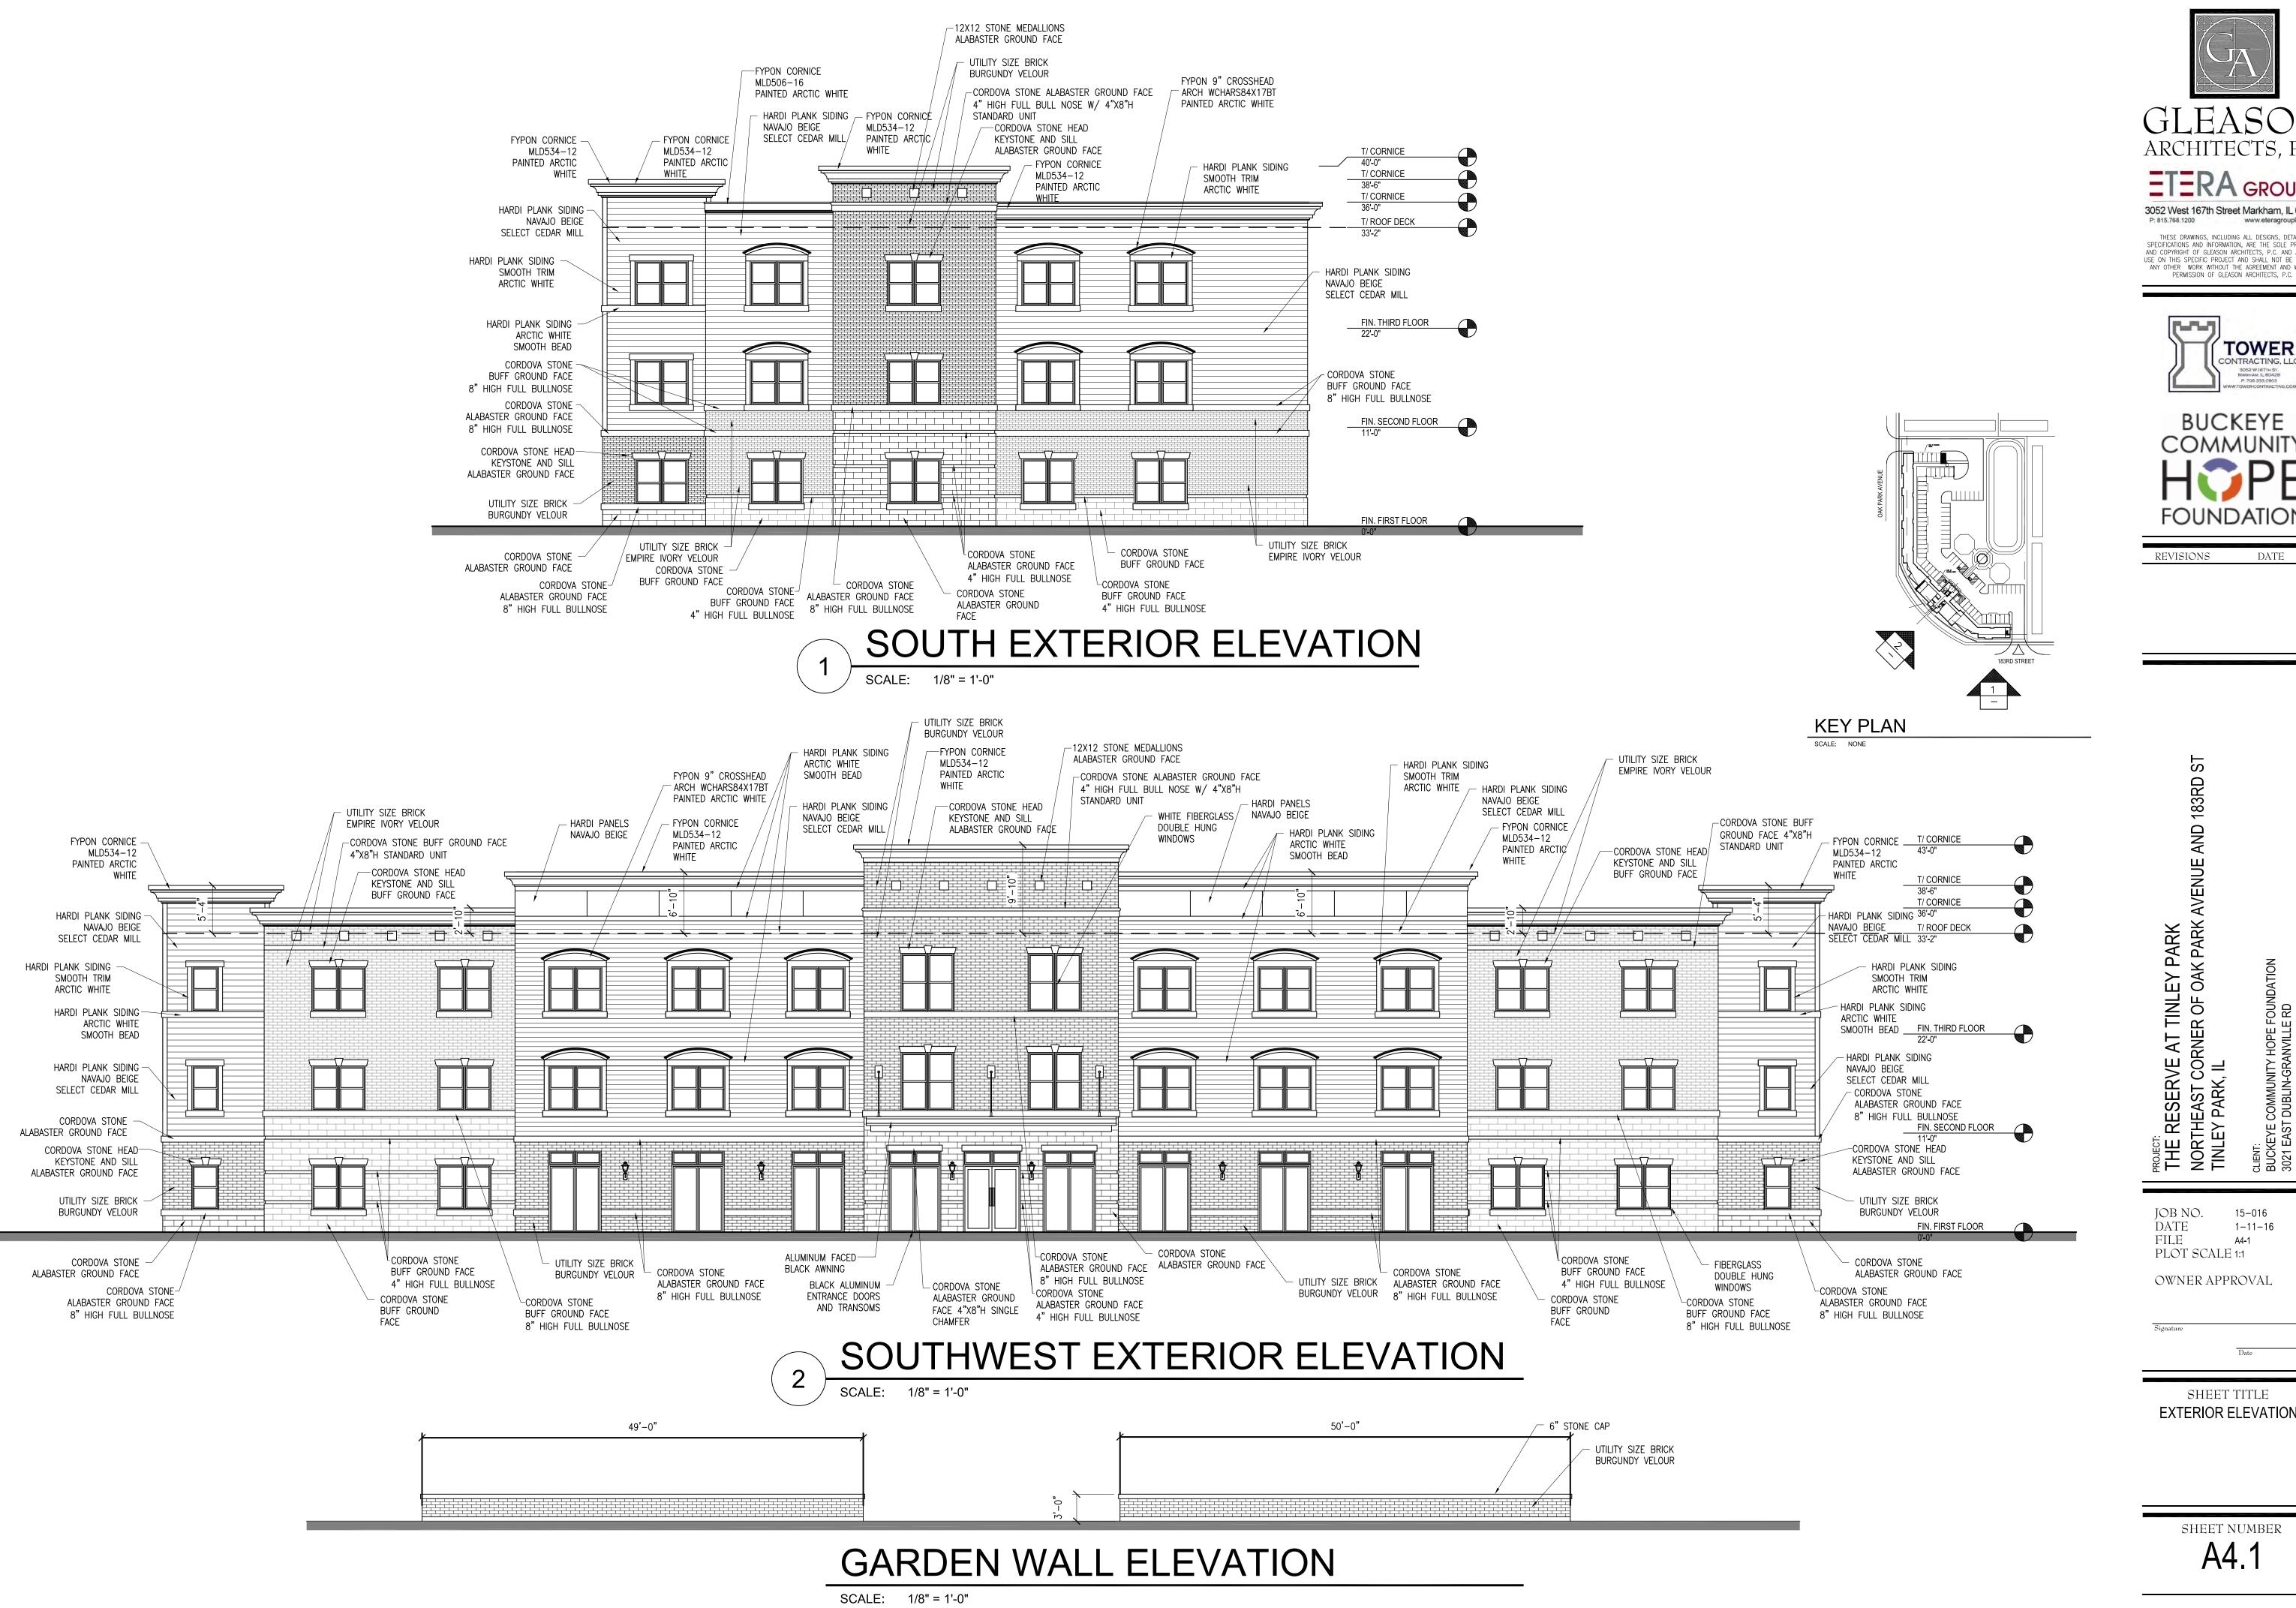

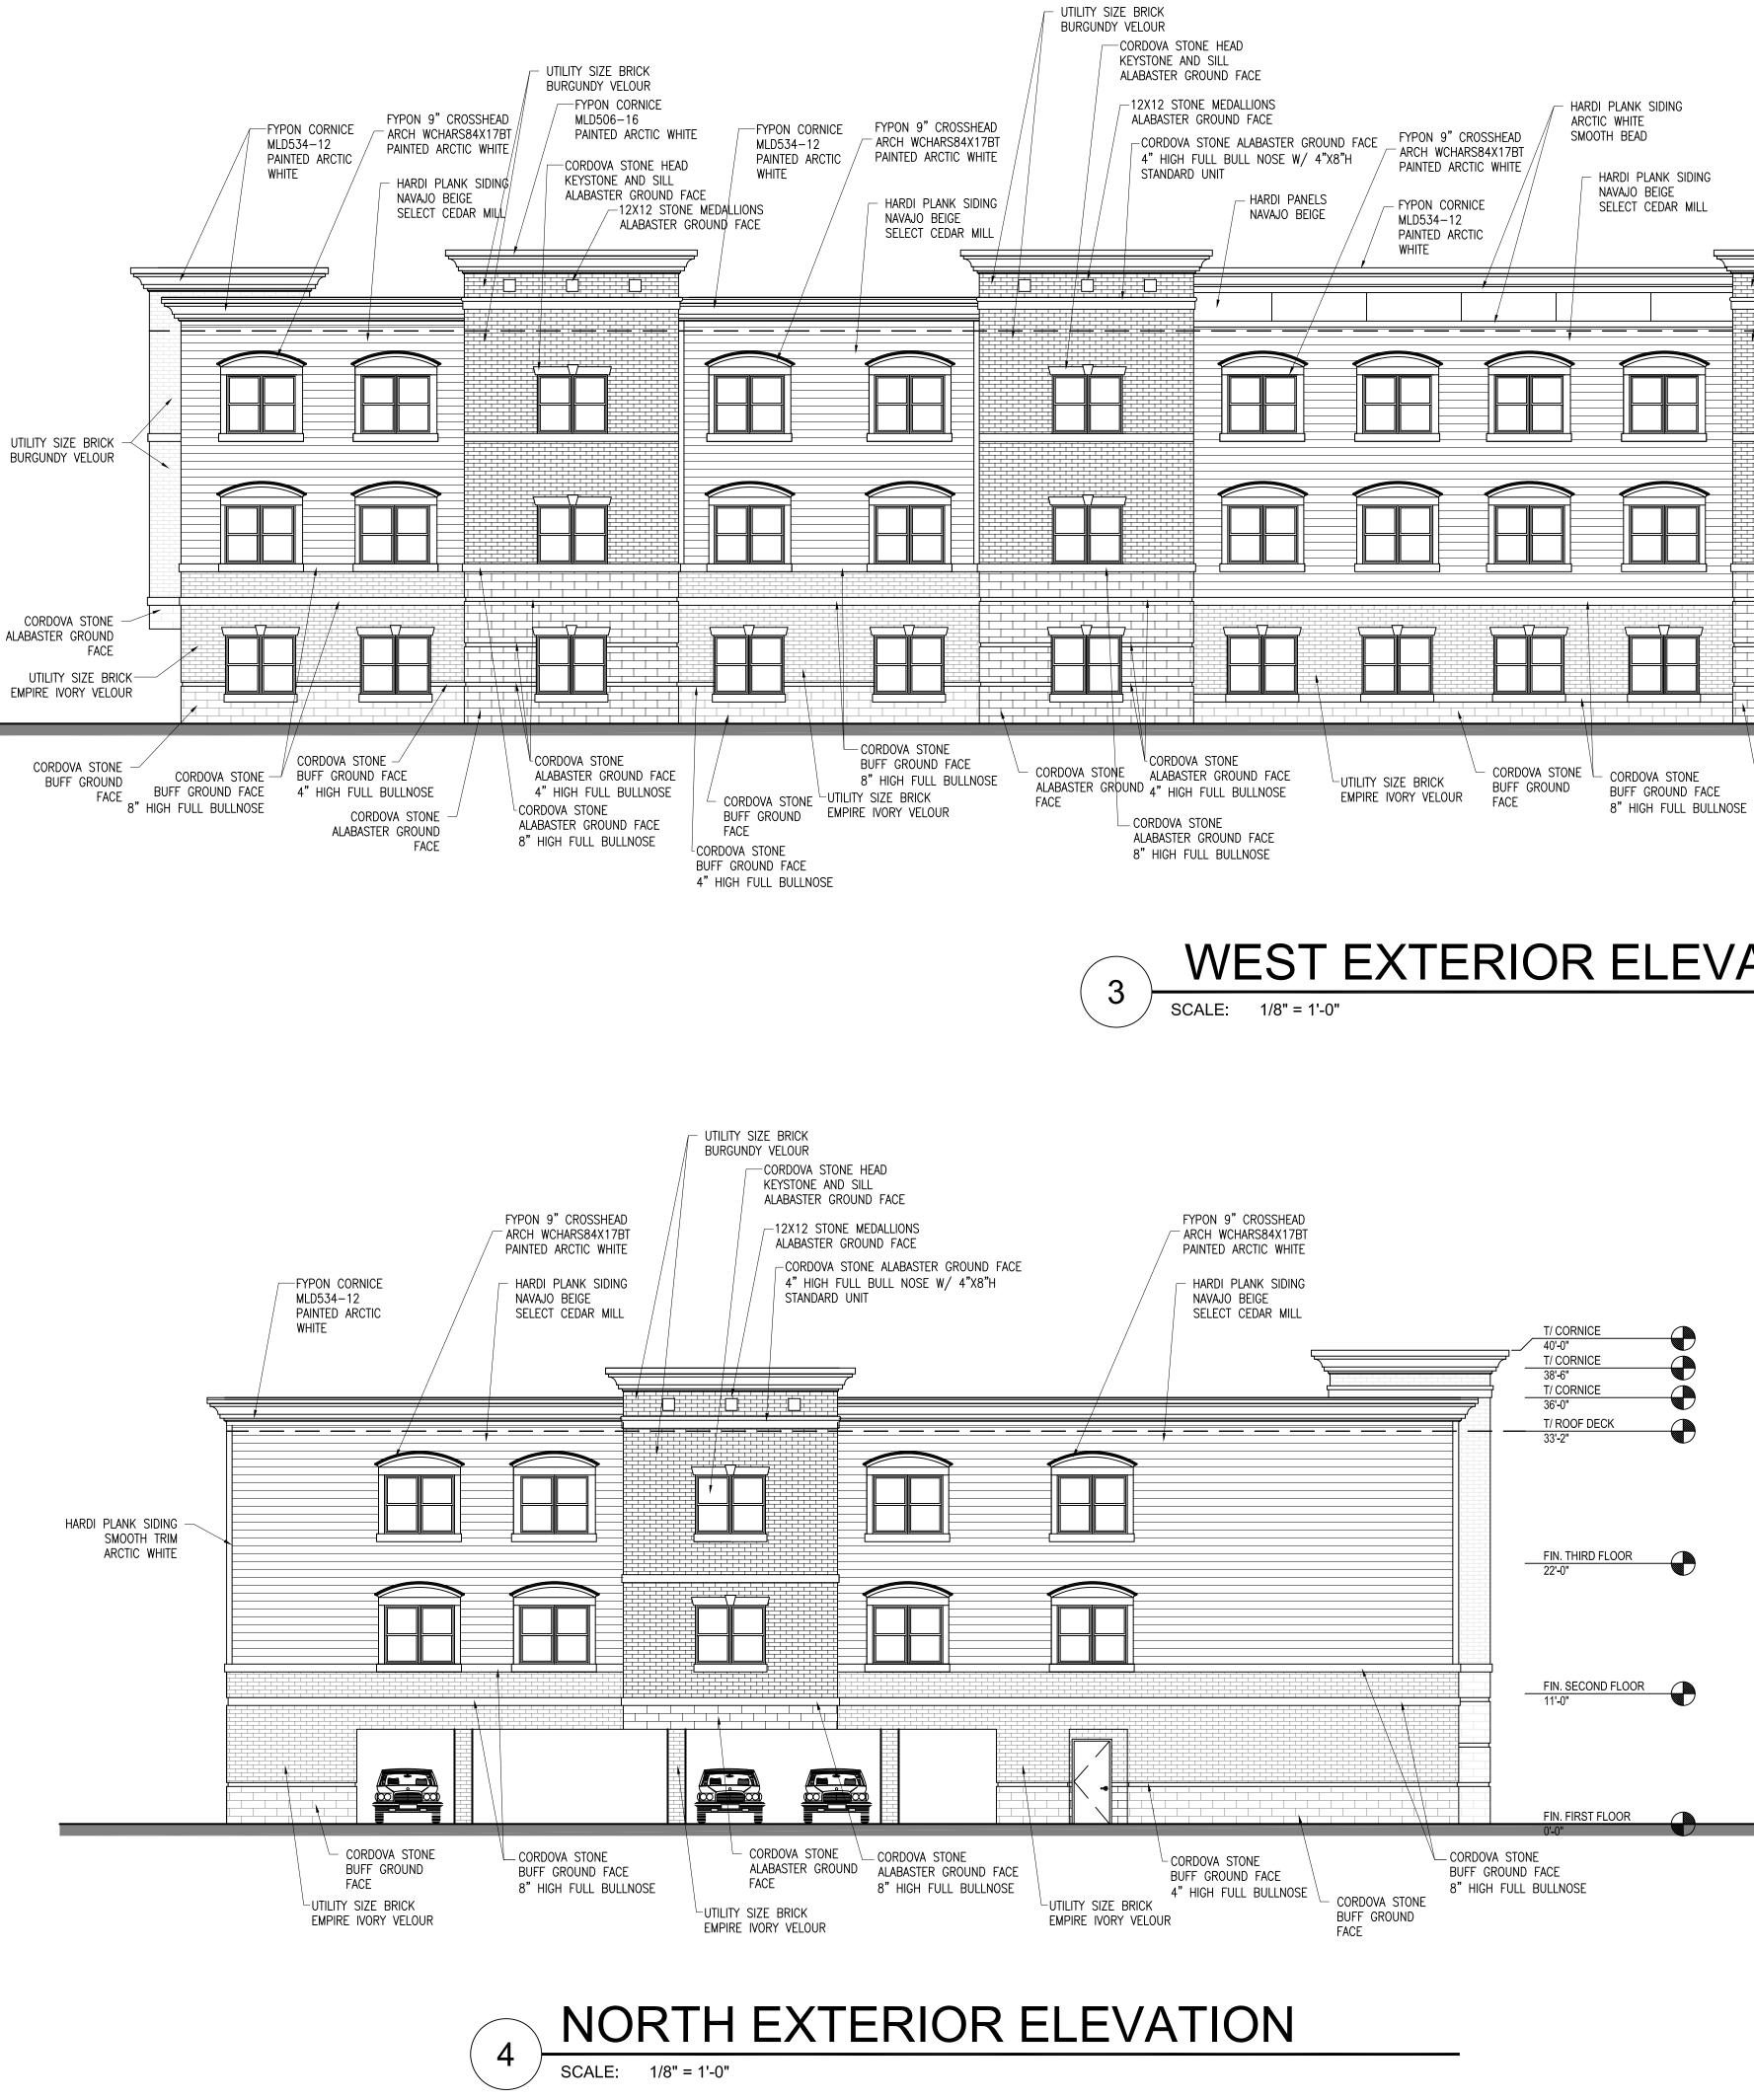

GH FULL BULL NOSE W/ 4"X8"H ARD UNIT HARDI PANELS NAVAJO BEIGE P/	HARDI PLANK SIDING ARCTIC WHITE SMOOTH BEAD HARDI PLANK SIDING NAVAJO BEIGE SELECT CEDAR MILL	CORDC KEYST ALABA	UR DRNICE	FYPON 9" CROSSHEAD ARCH WCHARS84X17BT PAINTED ARCTIC WHITE FYPON CORNICE MLD534-12 PAINTED ARCTIC WHITE	HARDI PLANK NAVAJO BEIGE SELECT CEDA
	····			····	
DOVA STONE BASTER GROUND FACE HIGH FULL BULLNOSE TA STONE TER GROUND FACE H FULL BULLNOSE		OSE CORDOVA STONE ALABASTER GROUND F. 4" HIGH FULL BULLNC CORDOVA STONE ALABASTER GROUND FACE		LOUR BUFF GROUND FACE 8" HIGH FULL BULLNOSE	CORDOVA STONE BUFF GROUND FACE


WEST EXTERIOR ELEVATION




4

KEY PLAN


SCALE: NONE

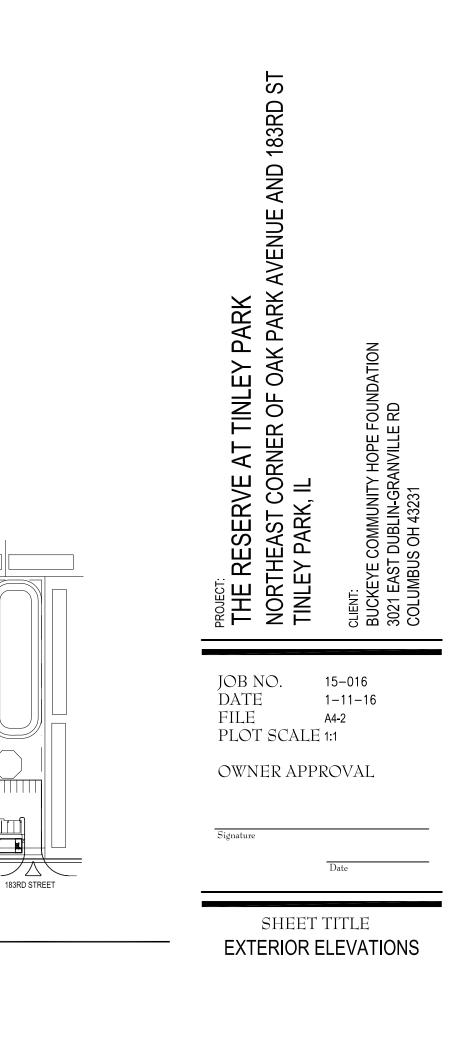

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5

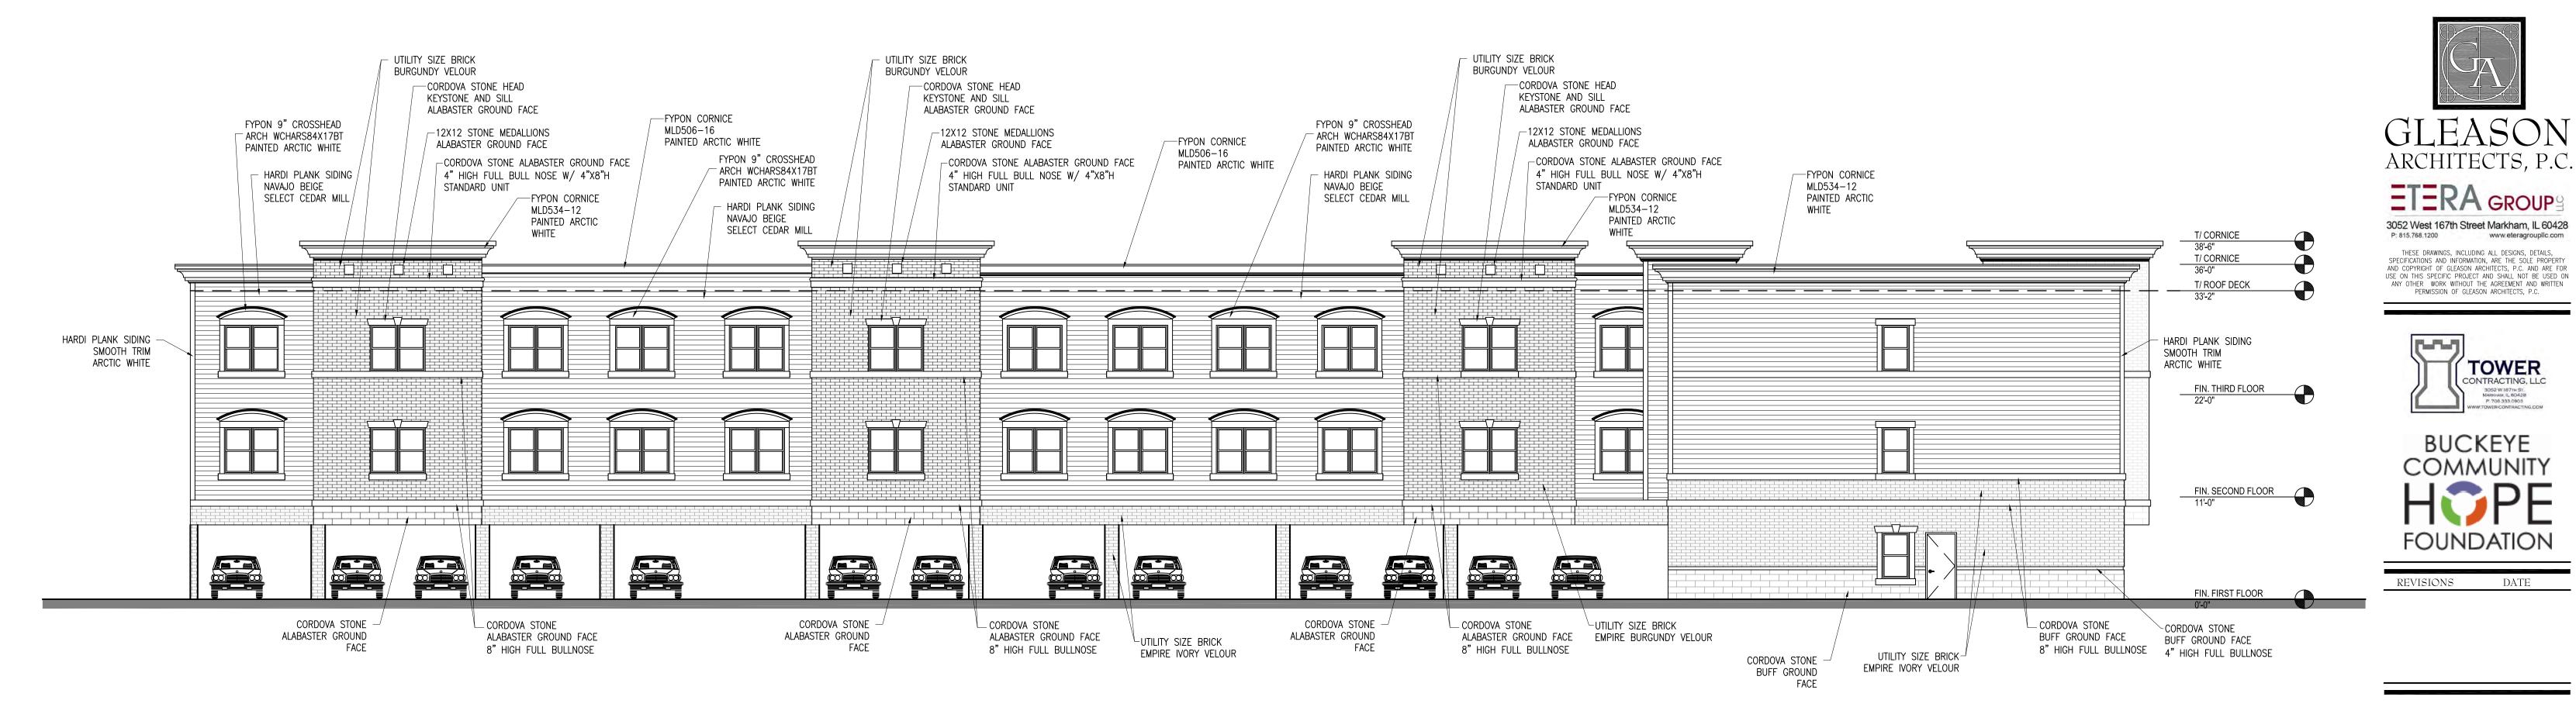

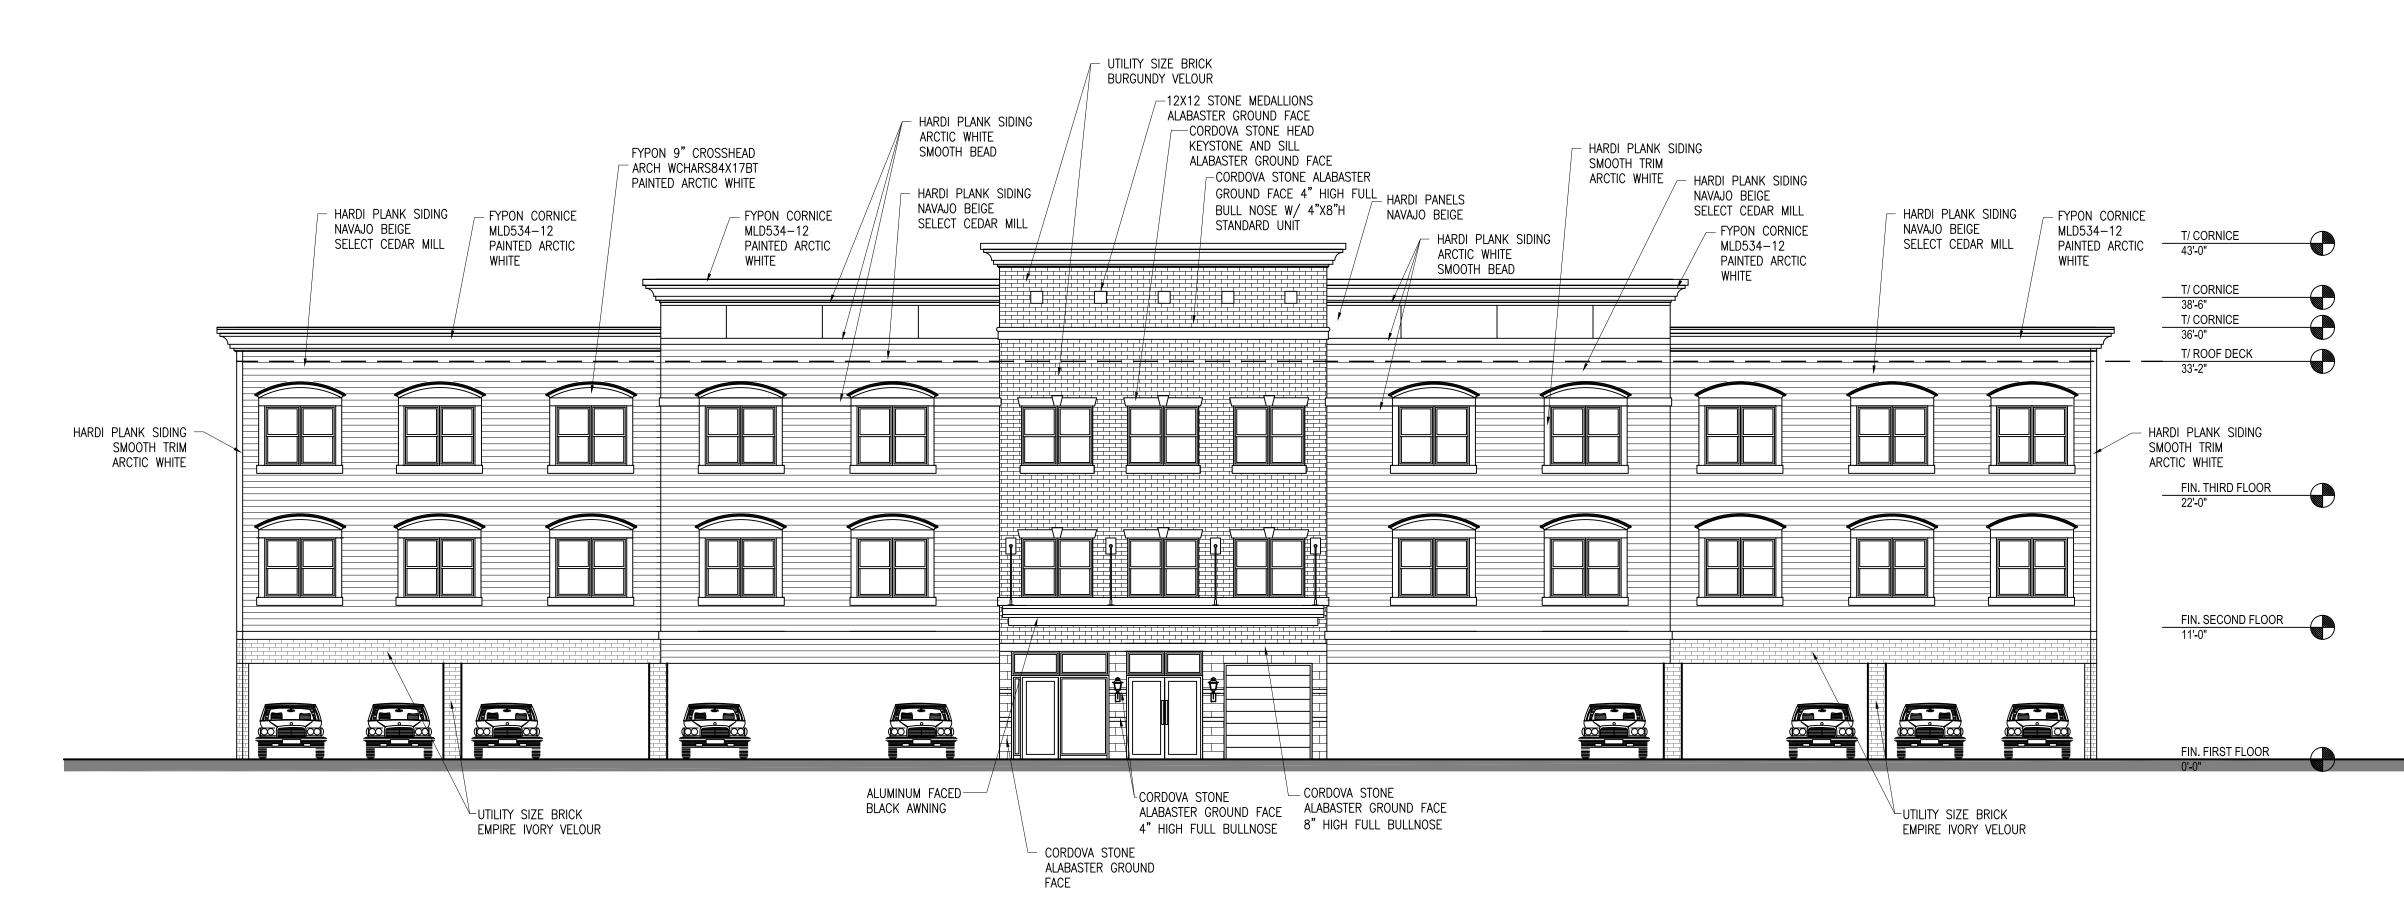

EAST EXTERIOR ELEVATION

SCALE: 1/8" = 1'-0"

NORTHEAST EXTERIOR ELEVATION




www.eteragrouplic.com

TOWER


CONTRACTING, LLC

3052 W.167тн St. Маякнам, IL 60428 Р. 708.333.0903

PF

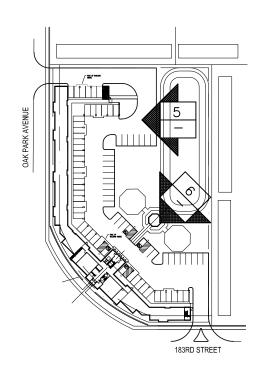

KEY PLAN SCALE: NONE

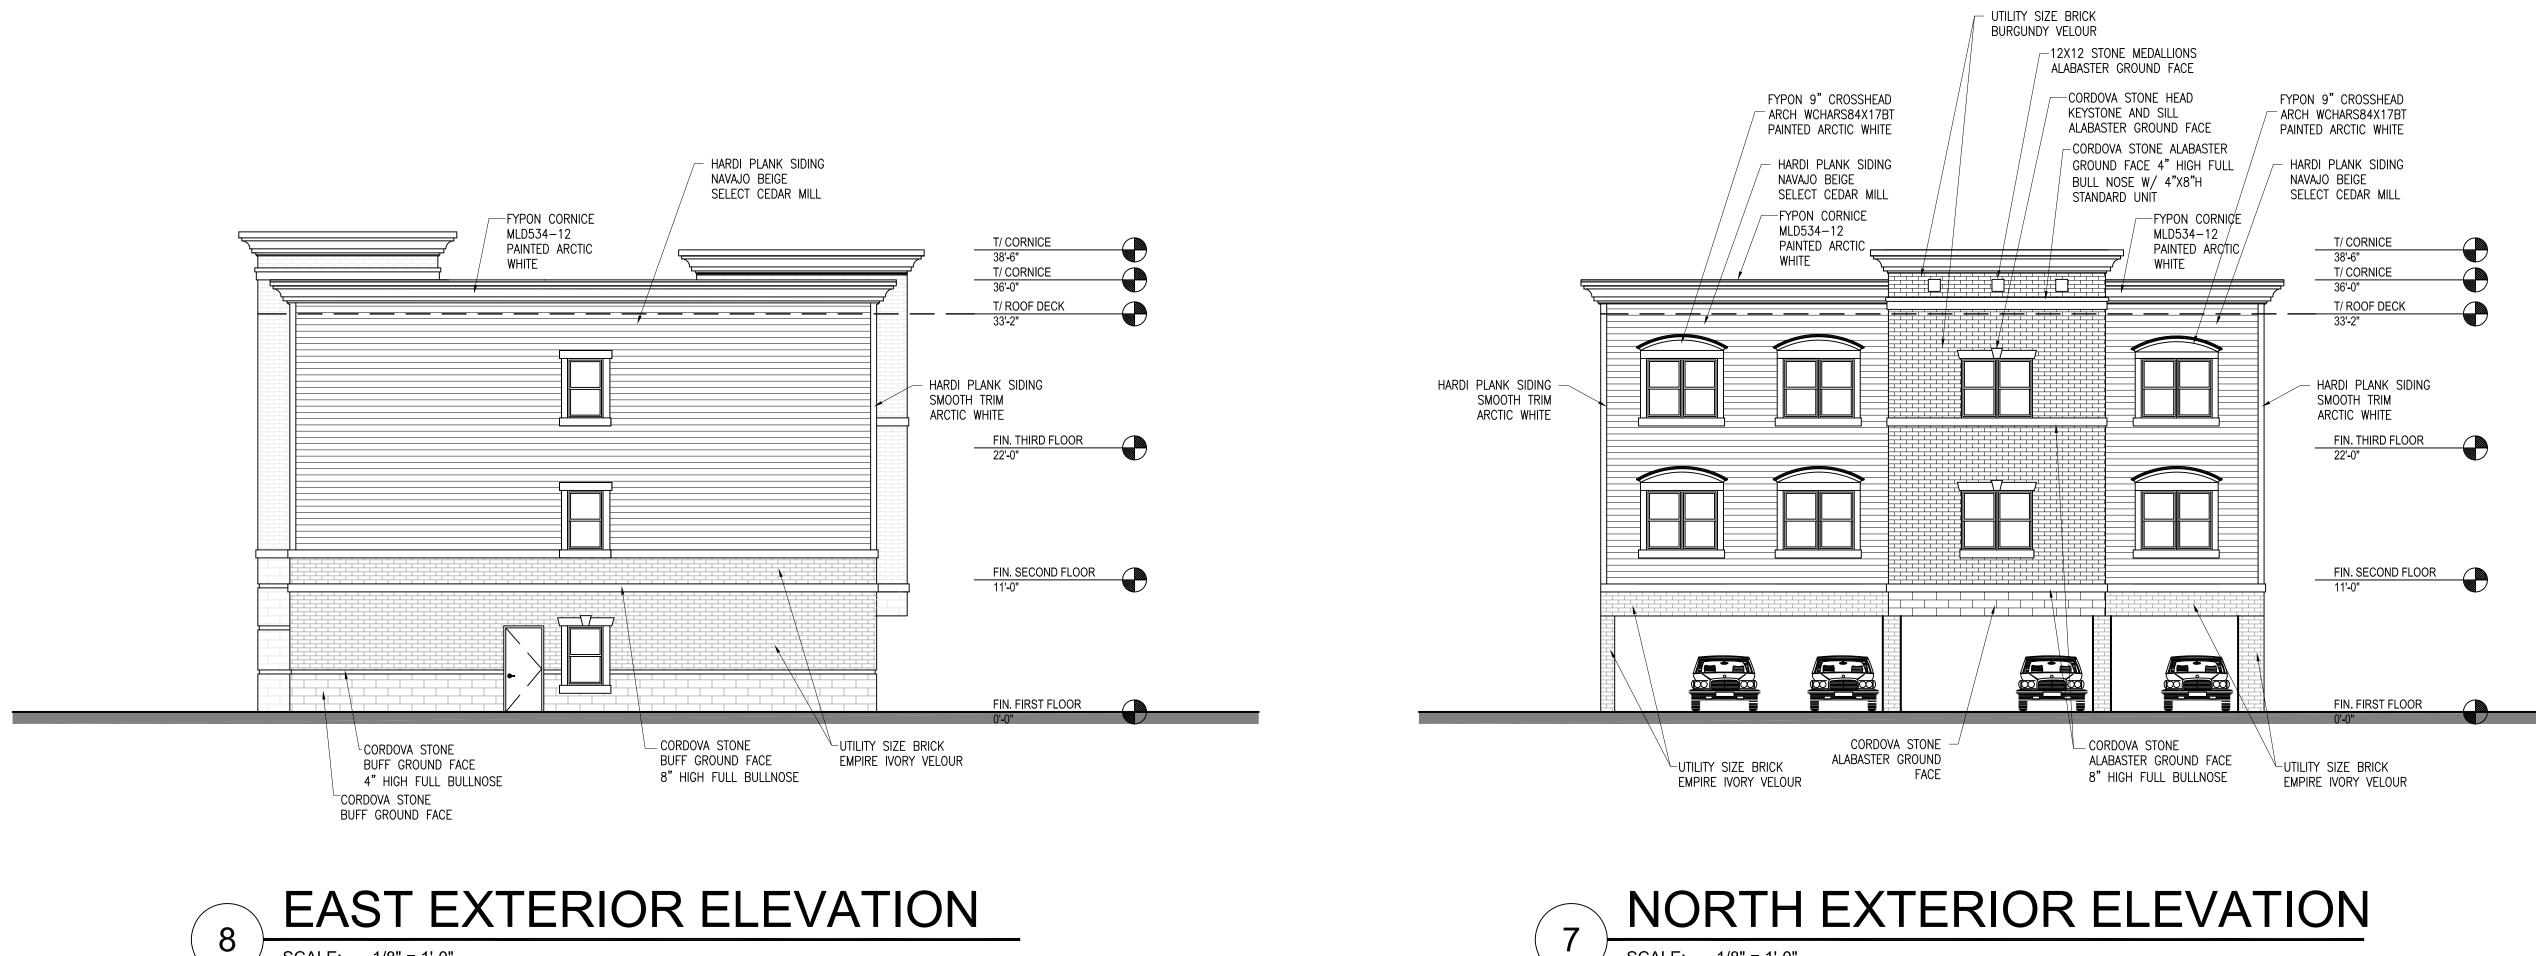


SCALE: 1/8" = 1'-0"








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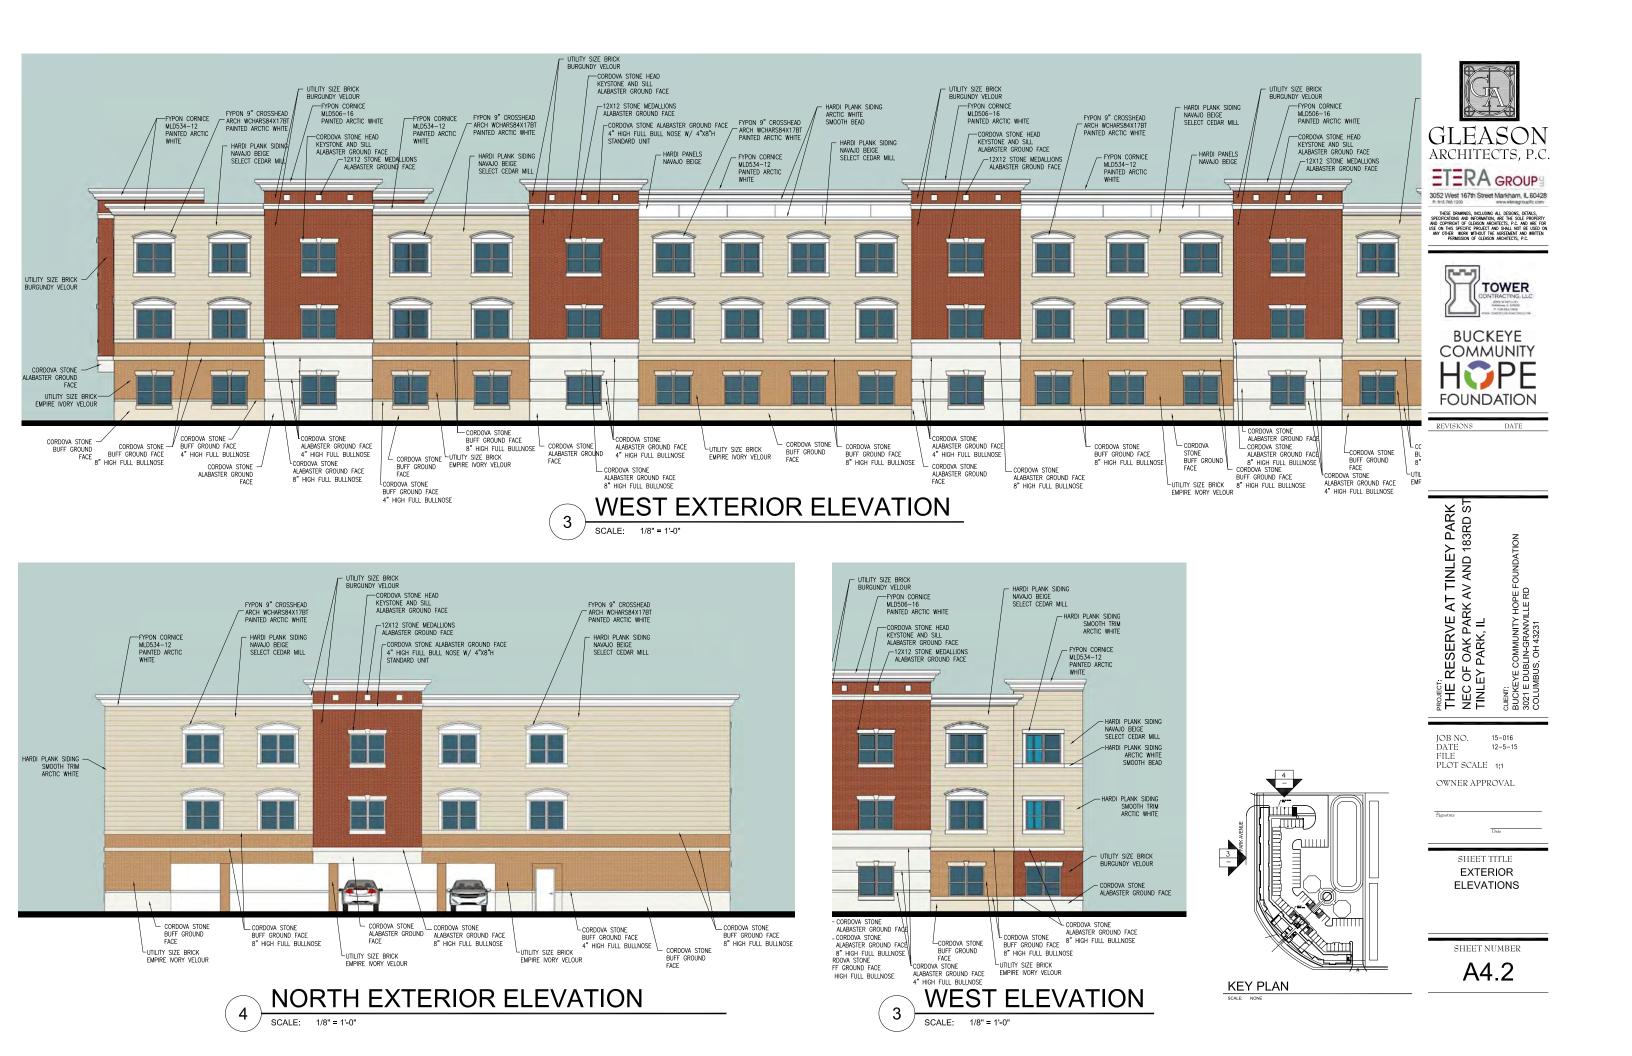


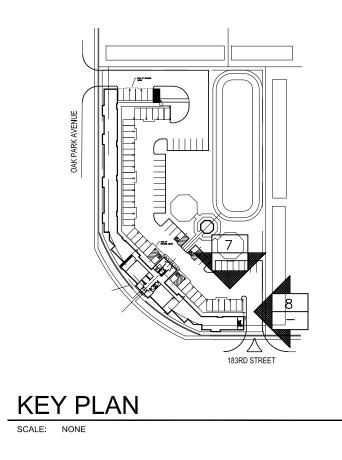


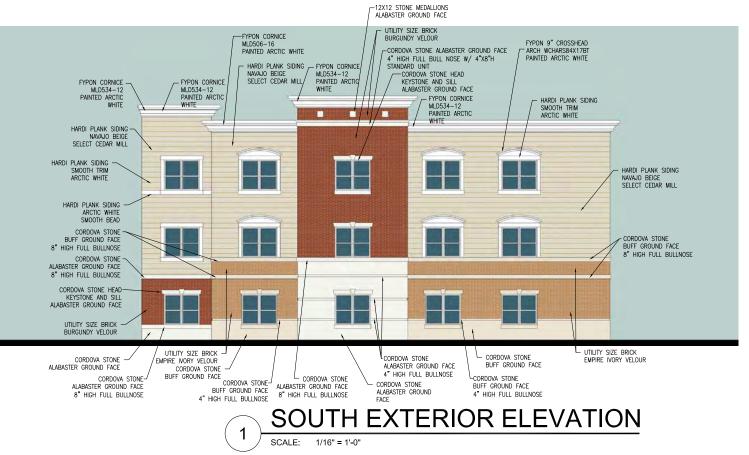


SCALE: NONE

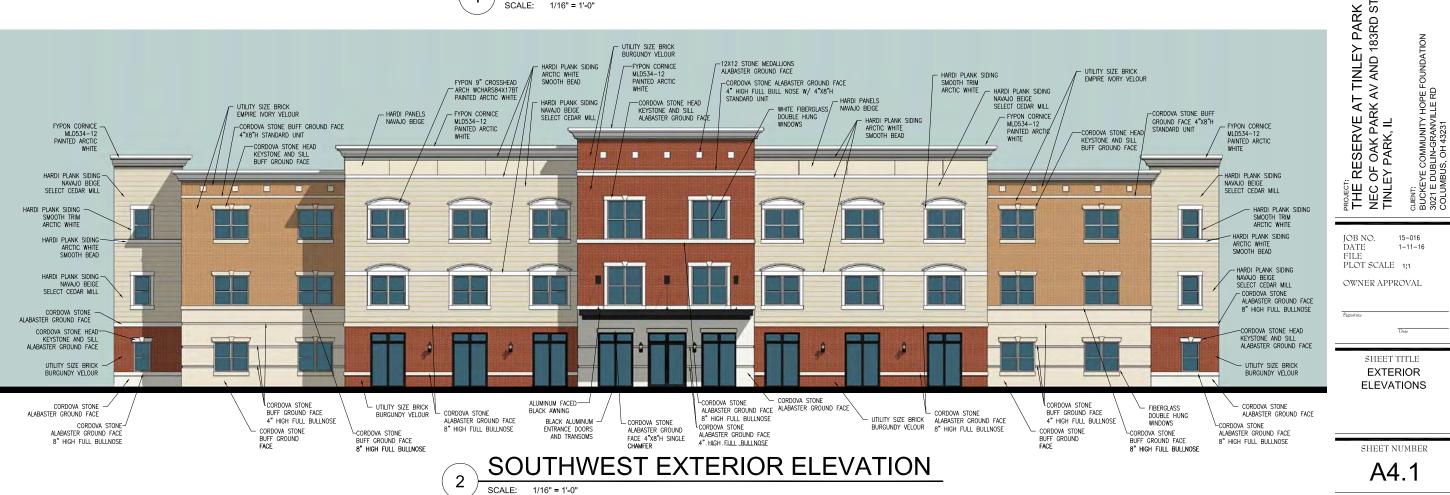

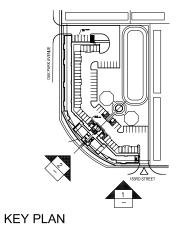

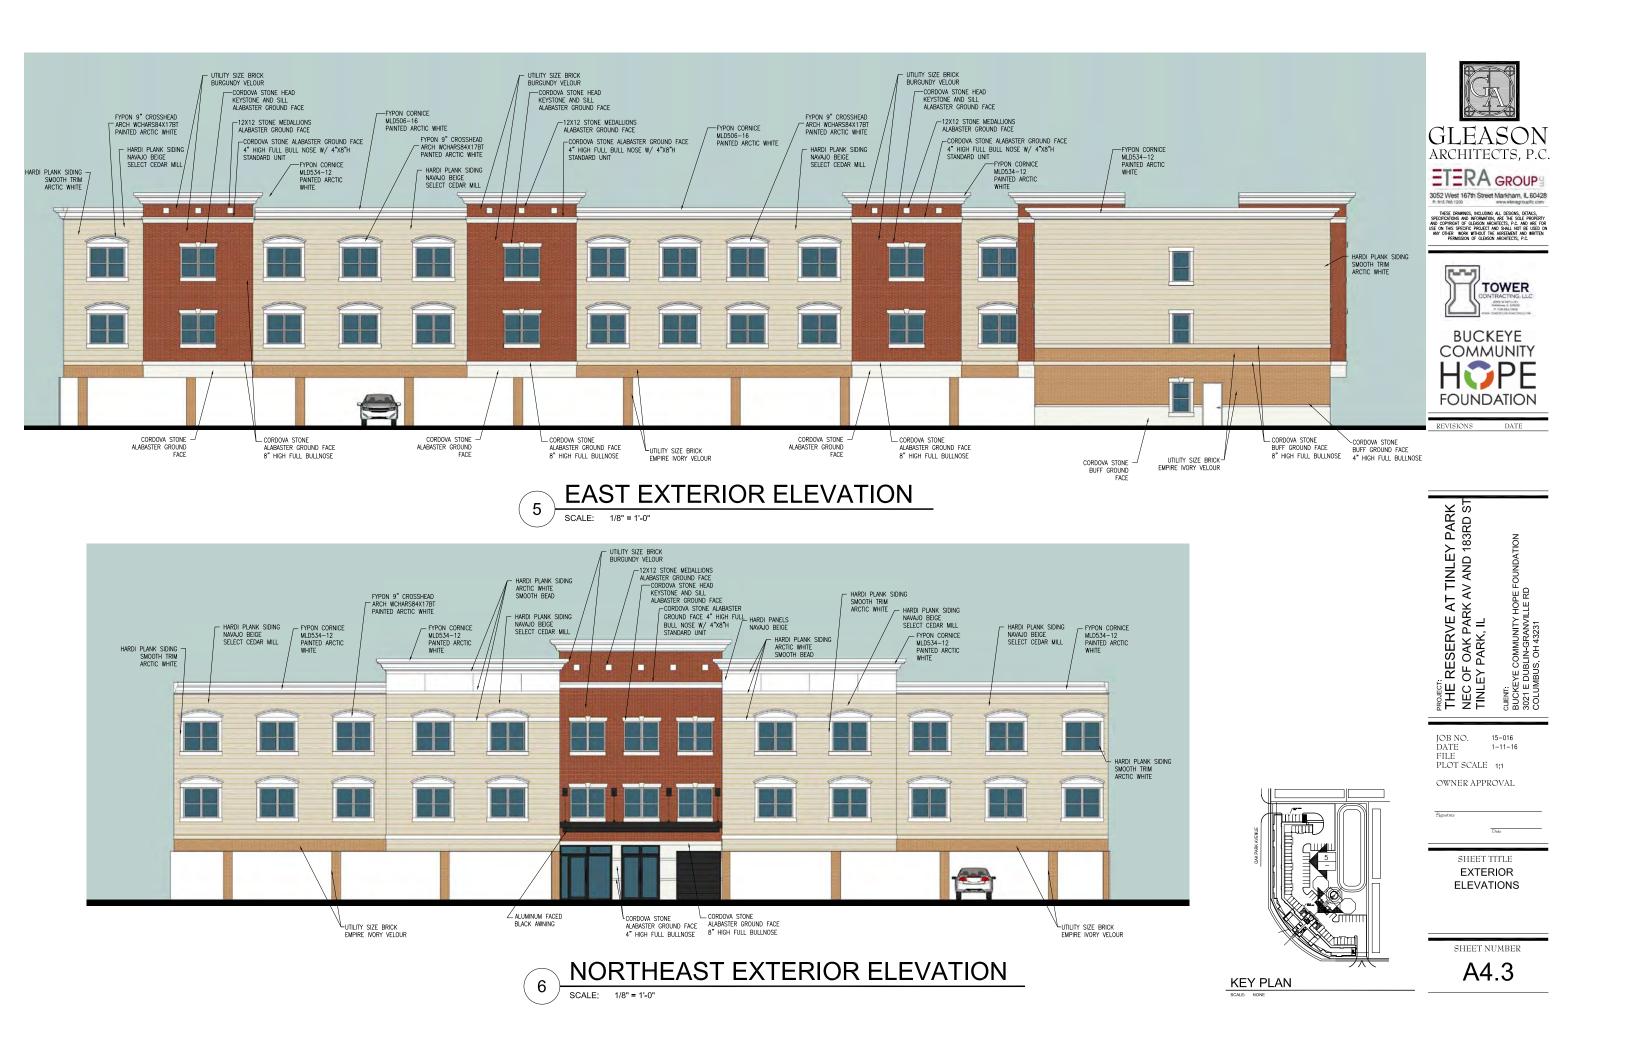



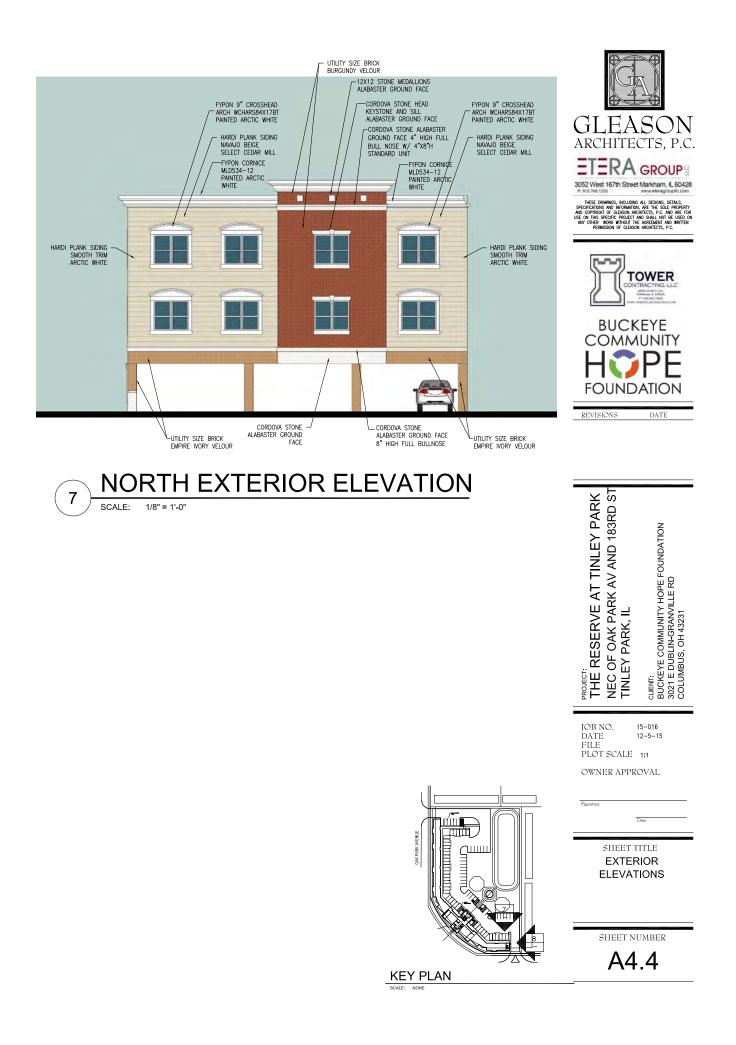















DATE

PROJECT: THE RESERVE AT TINLEY PARK NEC OF OAK PARK AV AND 183RD ST TINLEY PARK, IL BUCKEYE COMMUNITY HOPE FOUNDATION 3021 E DUBLIN-GRANVILLE RD COLUMBUS, OH 43231

JOB NO. 15-016 DATE 12-5-15 FILE PLOT SCALE 1:1 OWNER APPROVAL

SHEET TITLE

PERSPECTIVE

SHEET NUMBER

A5.2







REVISIONS



JOB NO. 15-016 DATE 12-5-15 FILE PLOT SCALE 1:1 OWNER APPROVAL

SHEET TITLE PERSPECTIVE

SHEET NUMBER

A5.3







PROJECT: THE RESERVE AT TINLEY PARK NEC OF OAK PARK AV AND 183RD ST TINLEY PARK, IL BUCKEYE COMMUNITY HOPE FOUNDATION 3021 E DUBLIN-GRANVILLE RD COLUMBUS, OH 43231


JOB NO. 15-016 DATE 1-11-16 FILE PLOT SCALE 1:1 OWNER APPROVAL

SHEET TITLE PERSPECTIVE

Date

SHEET NUMBER


A5.4

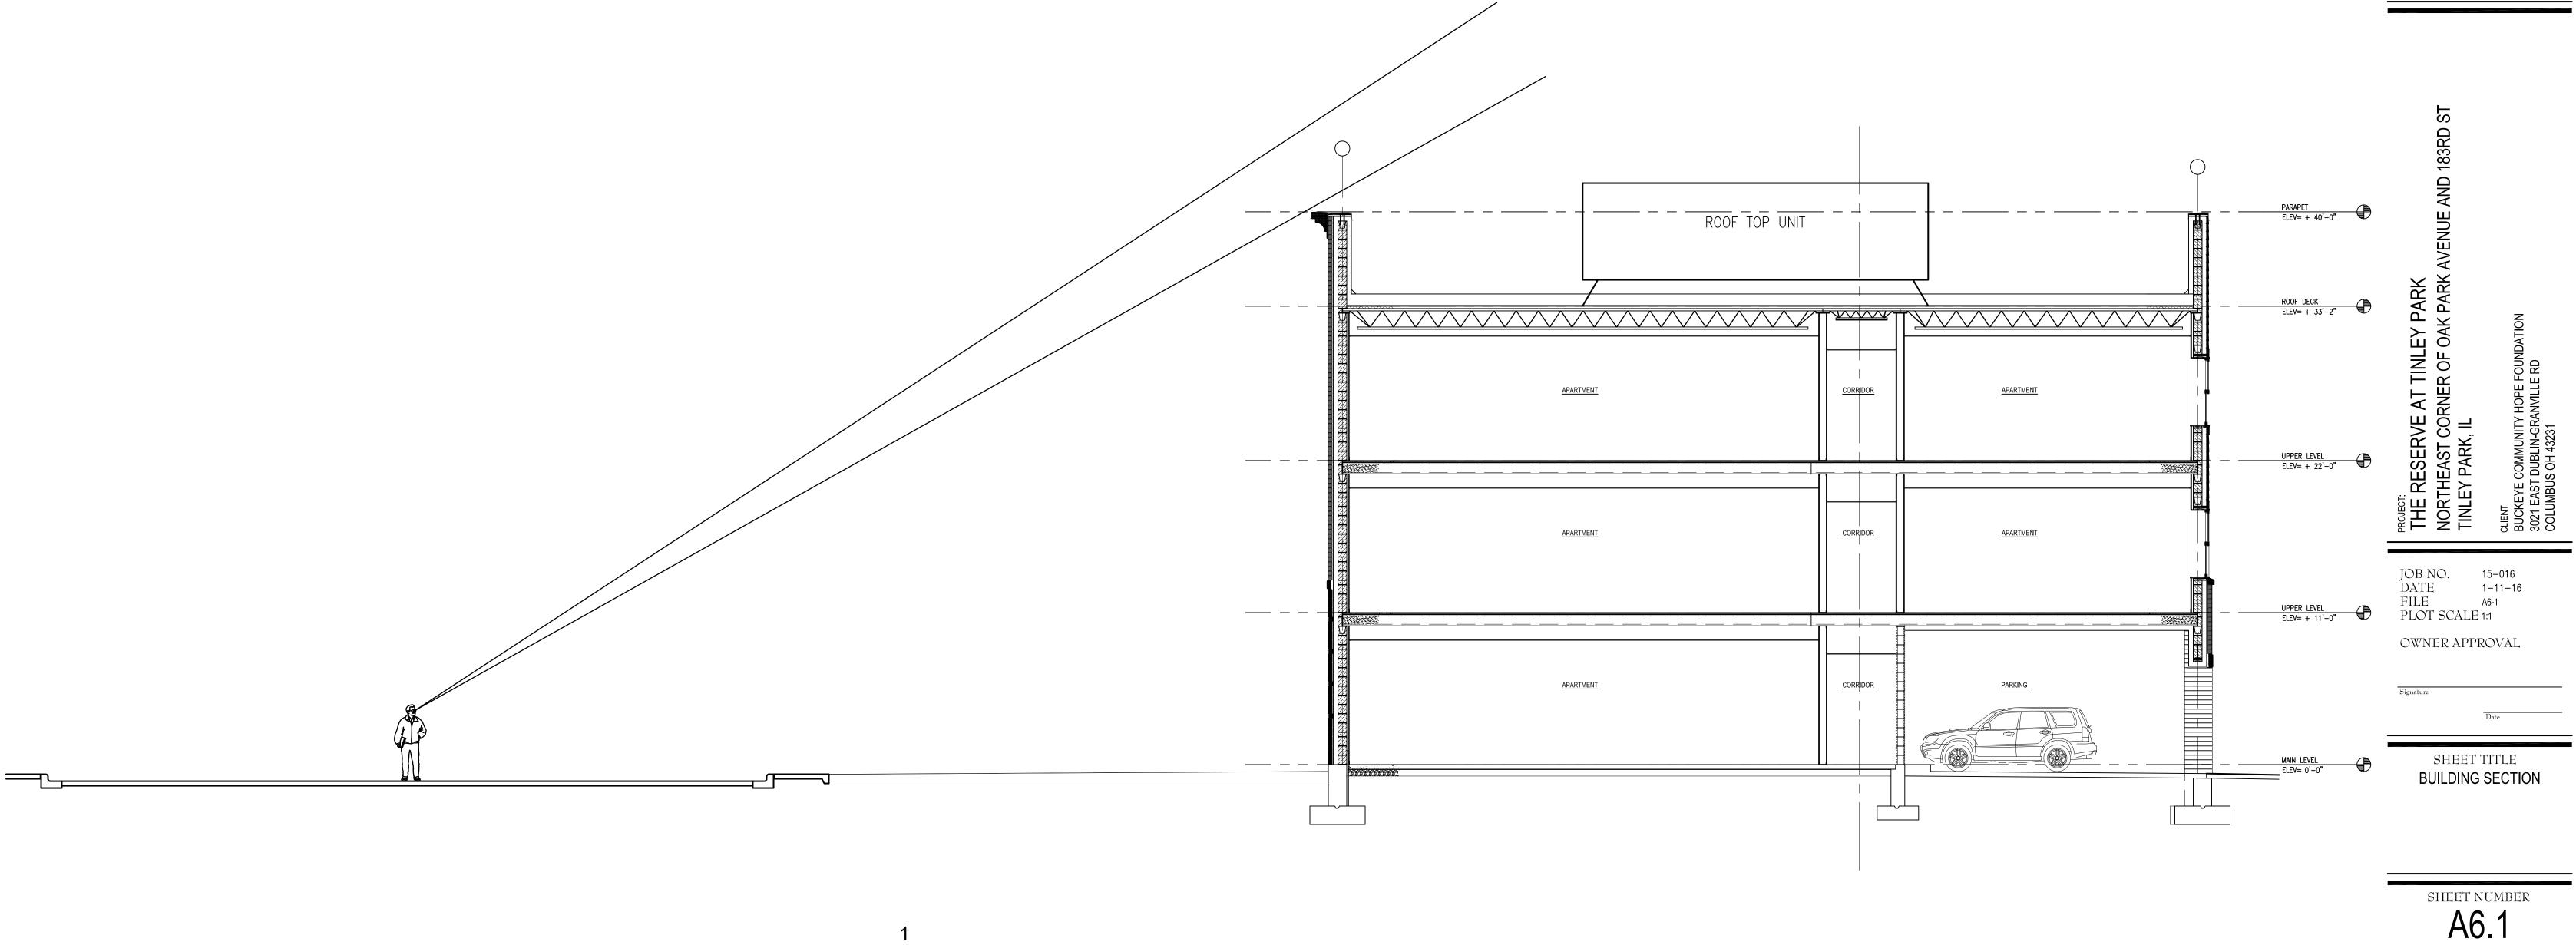



BUILDING SECTION SCALE: 3/16" = 1'-0"



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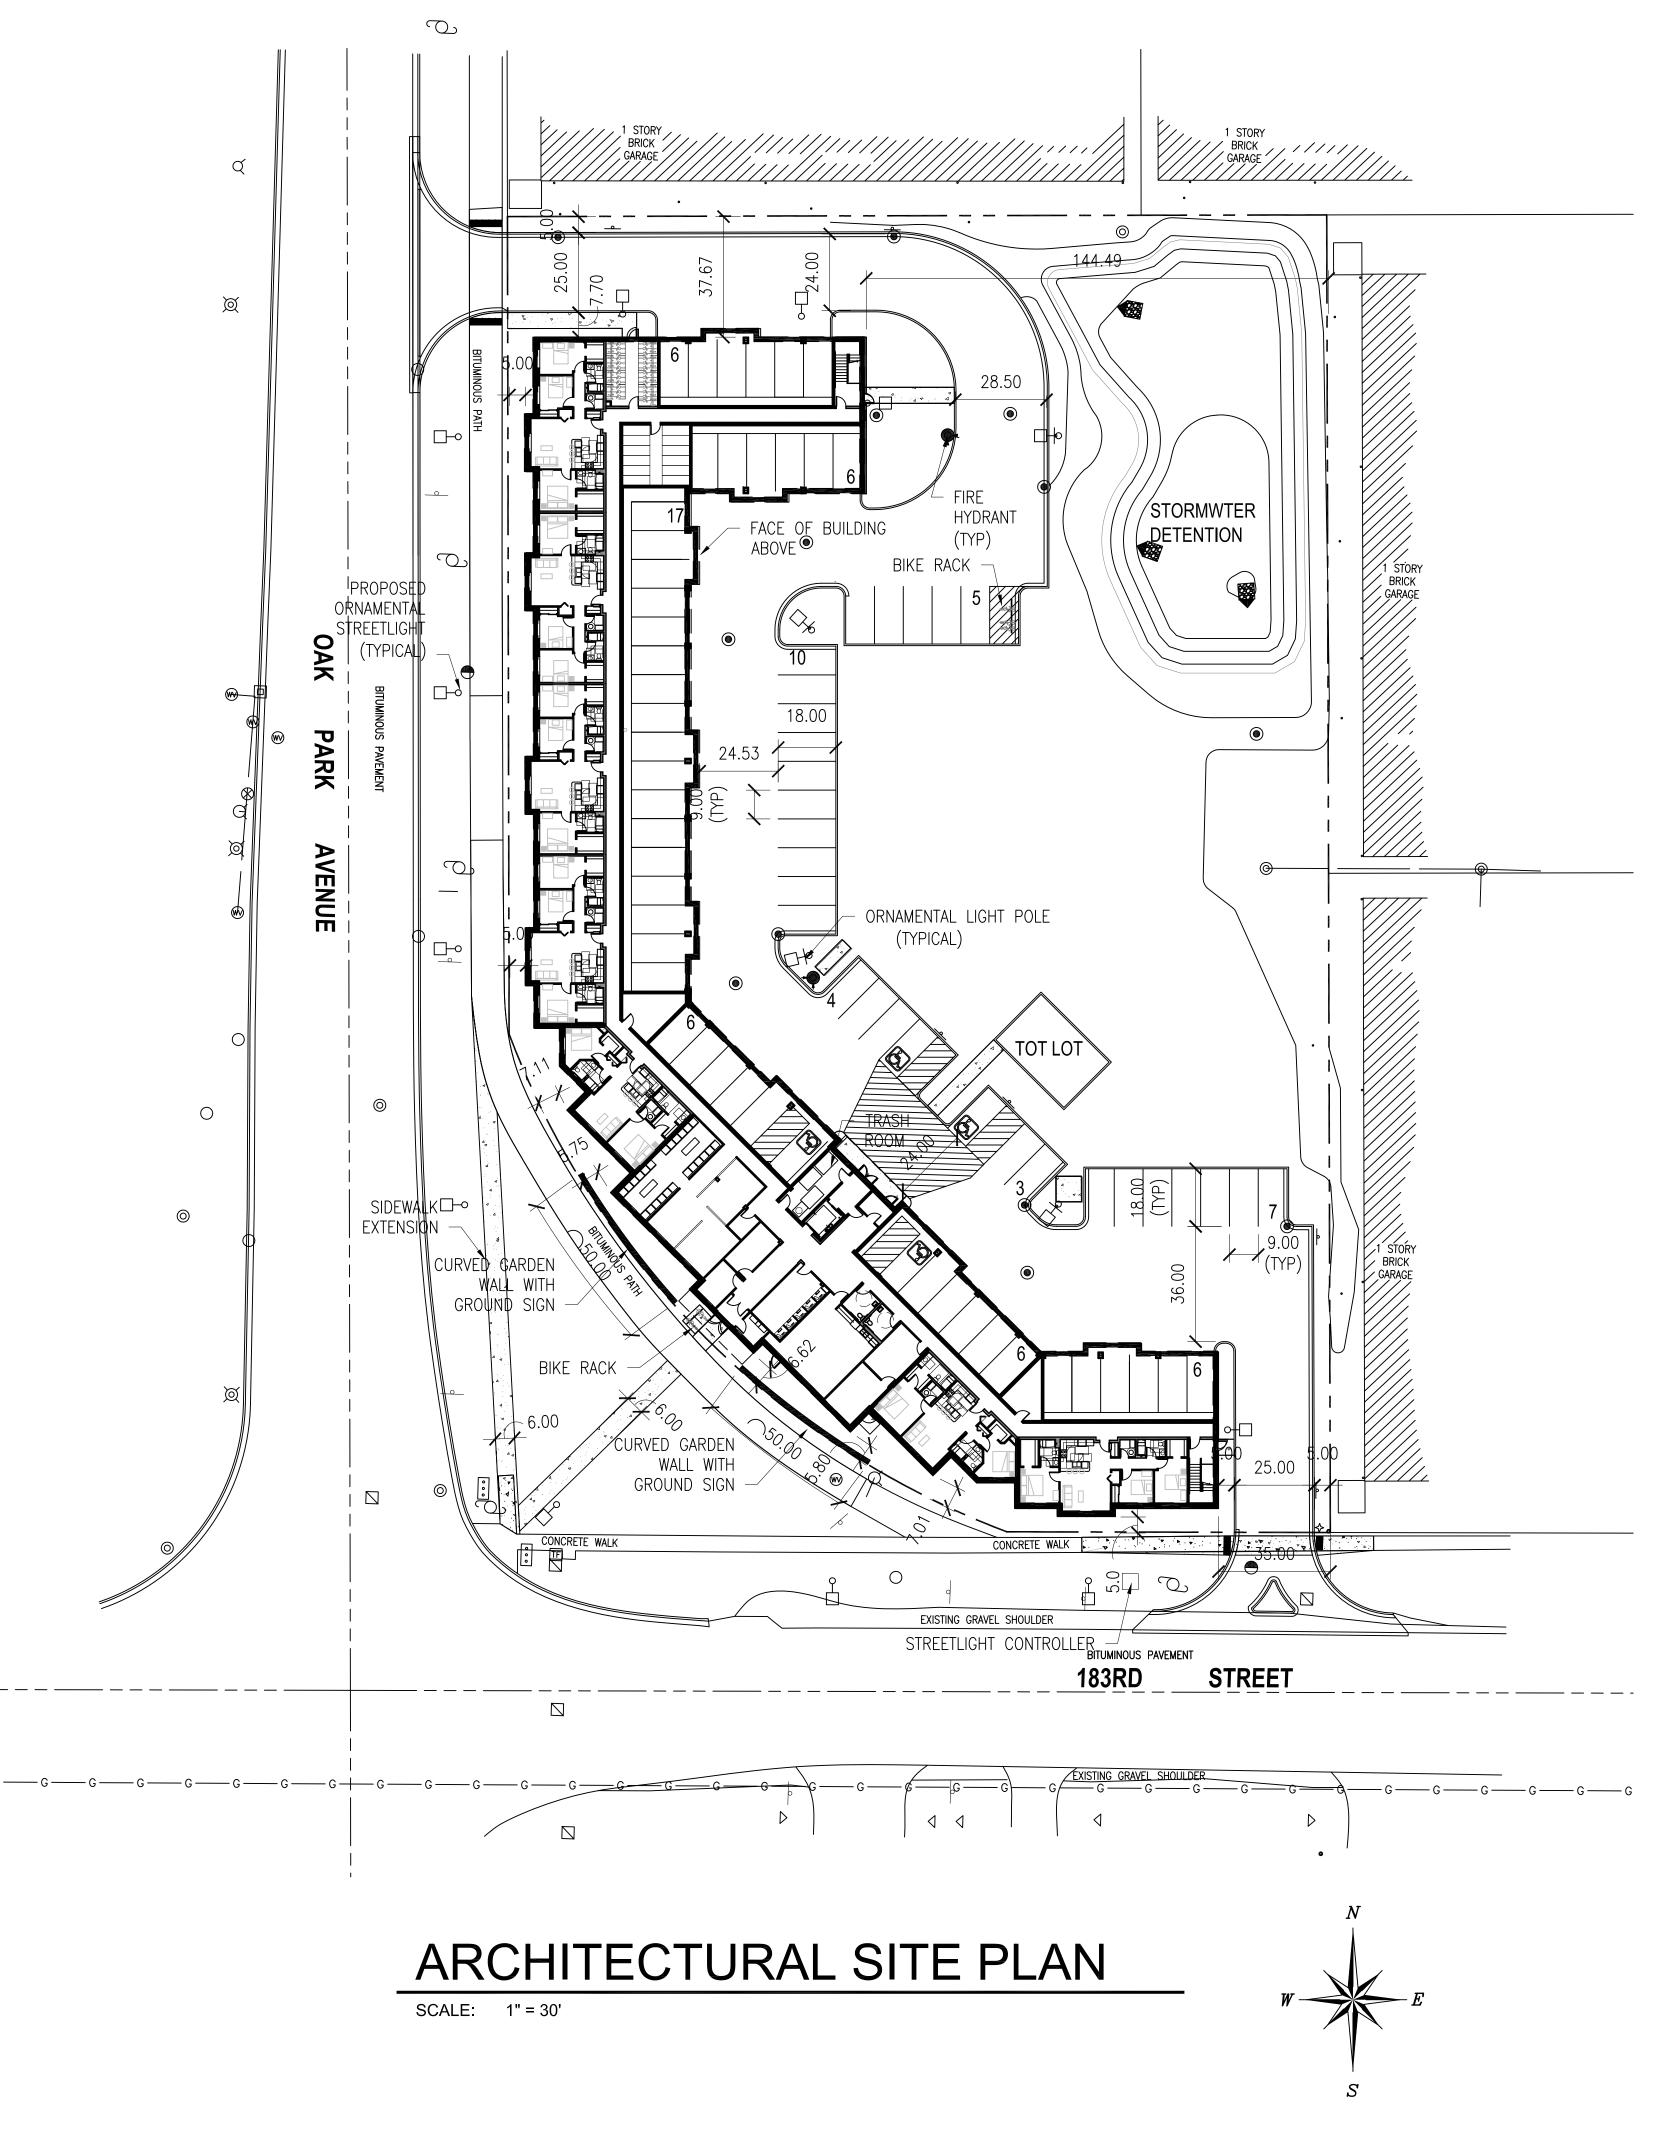


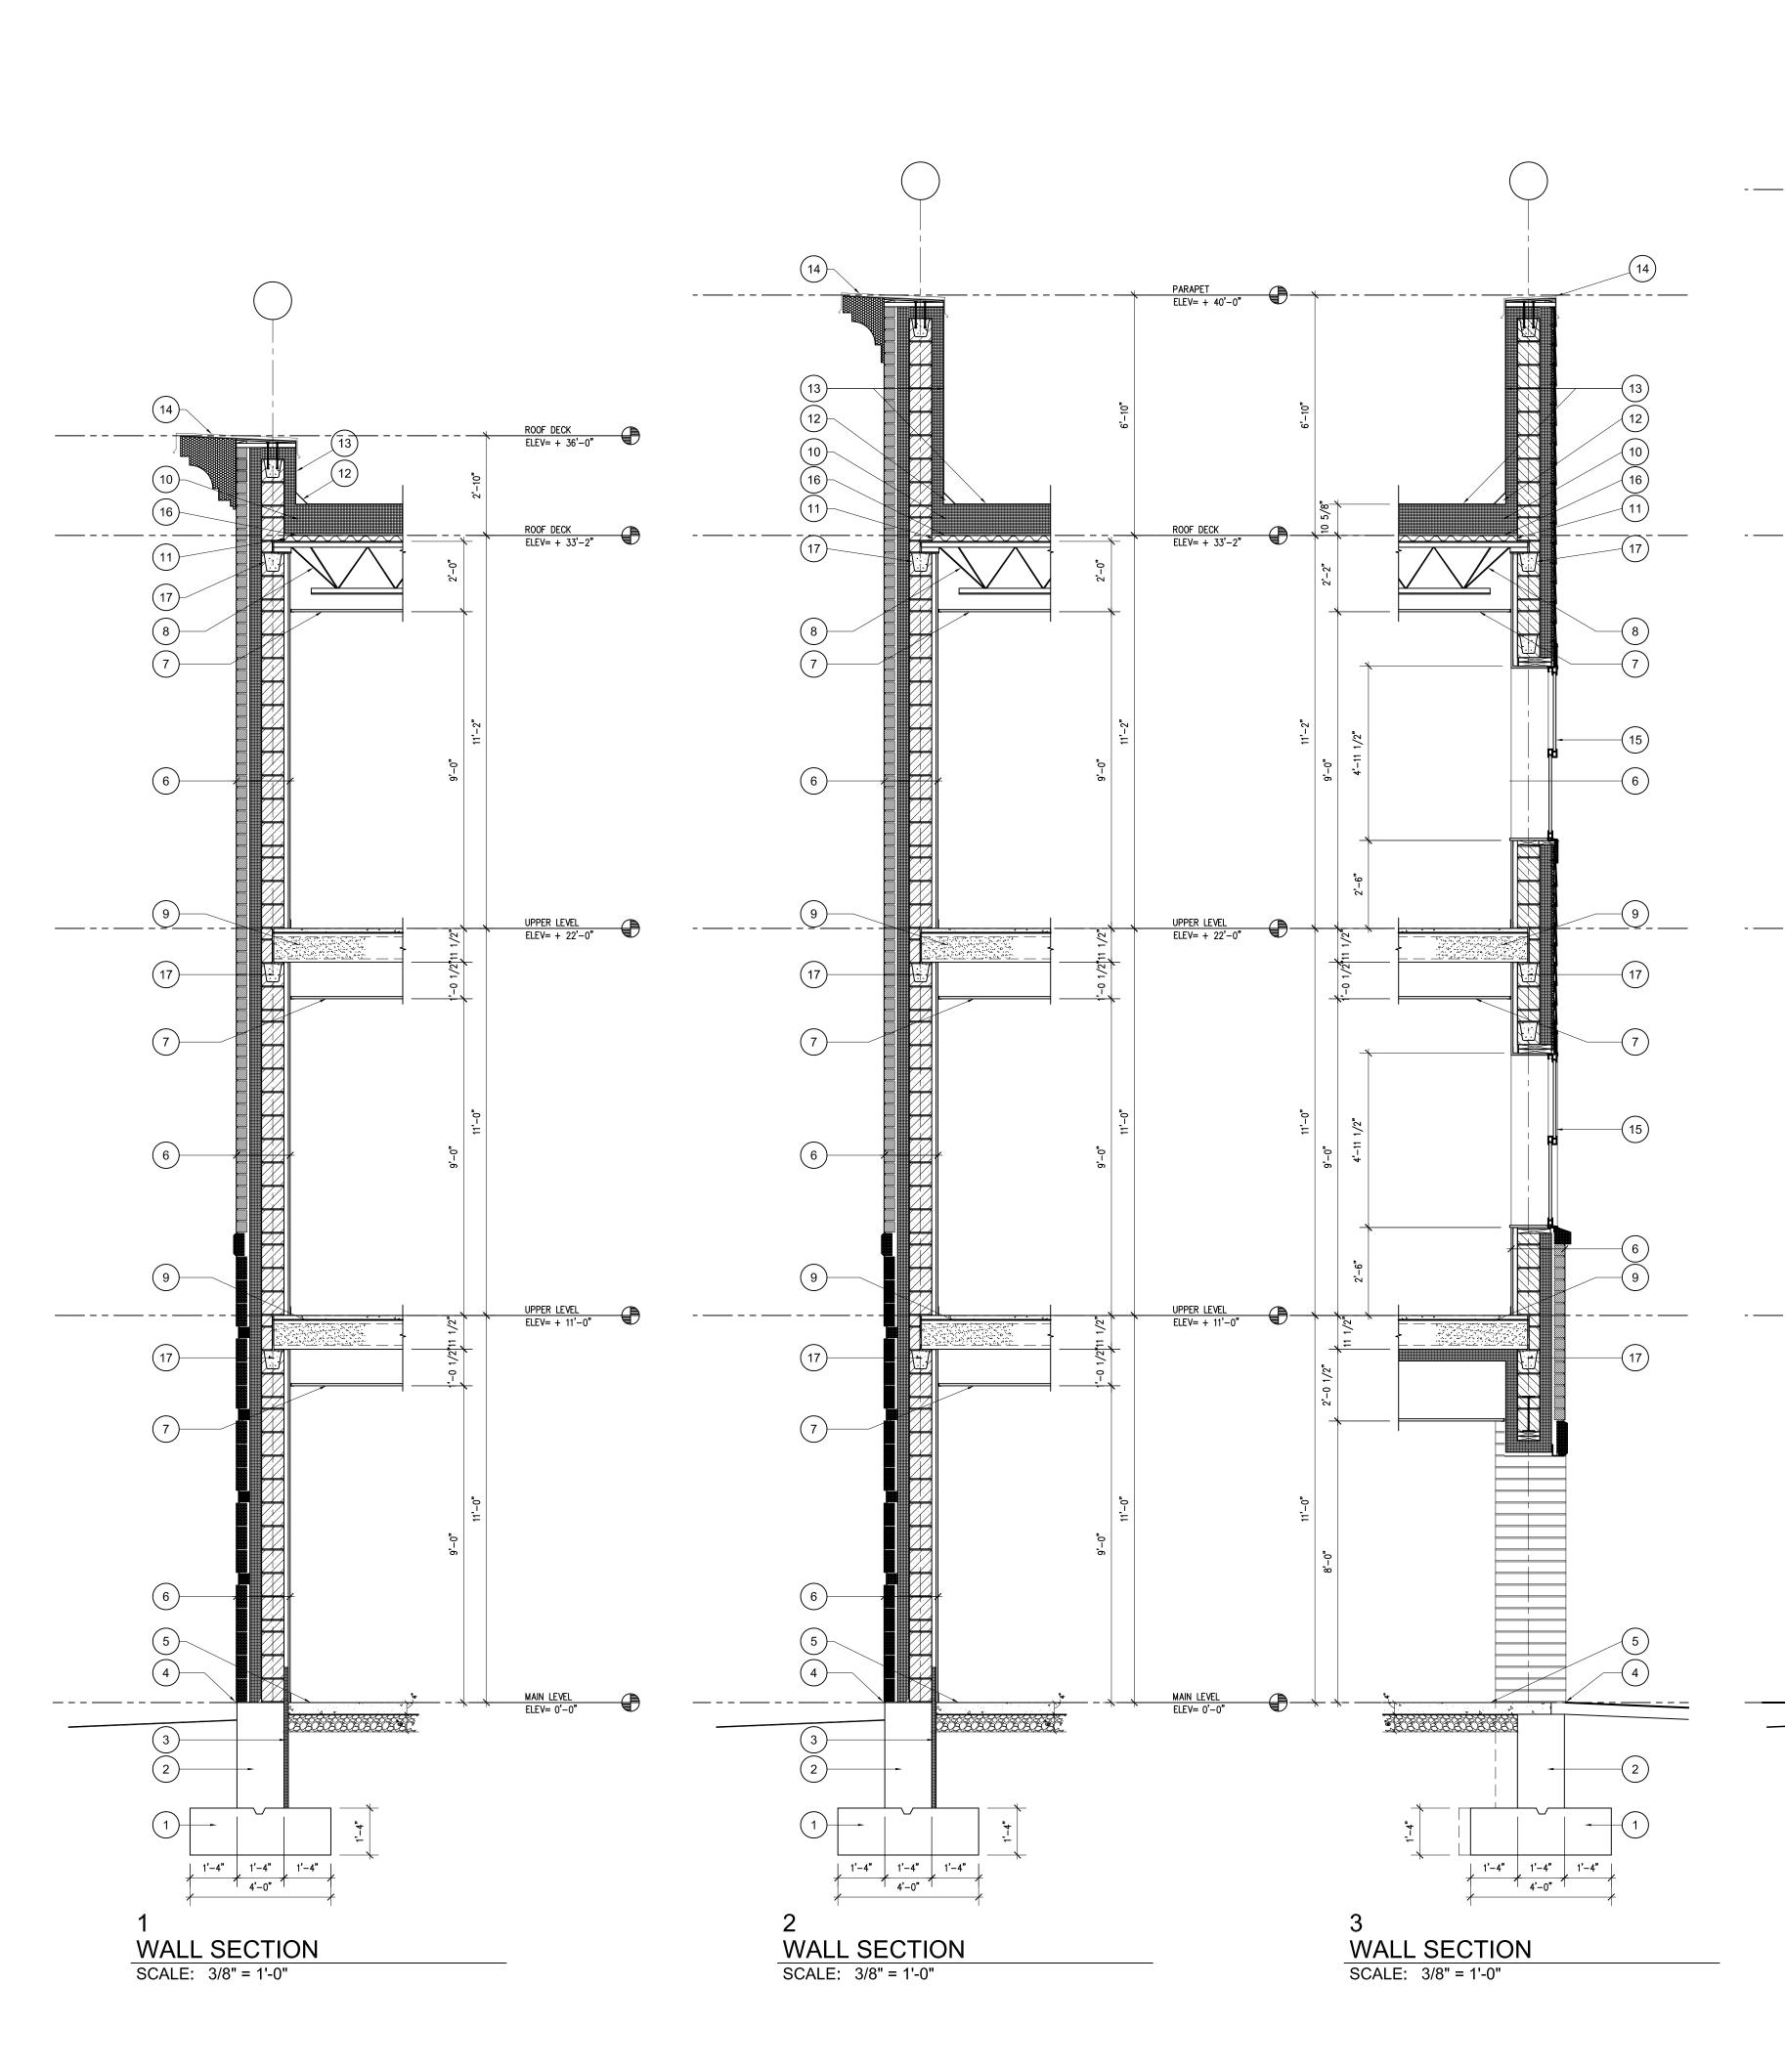


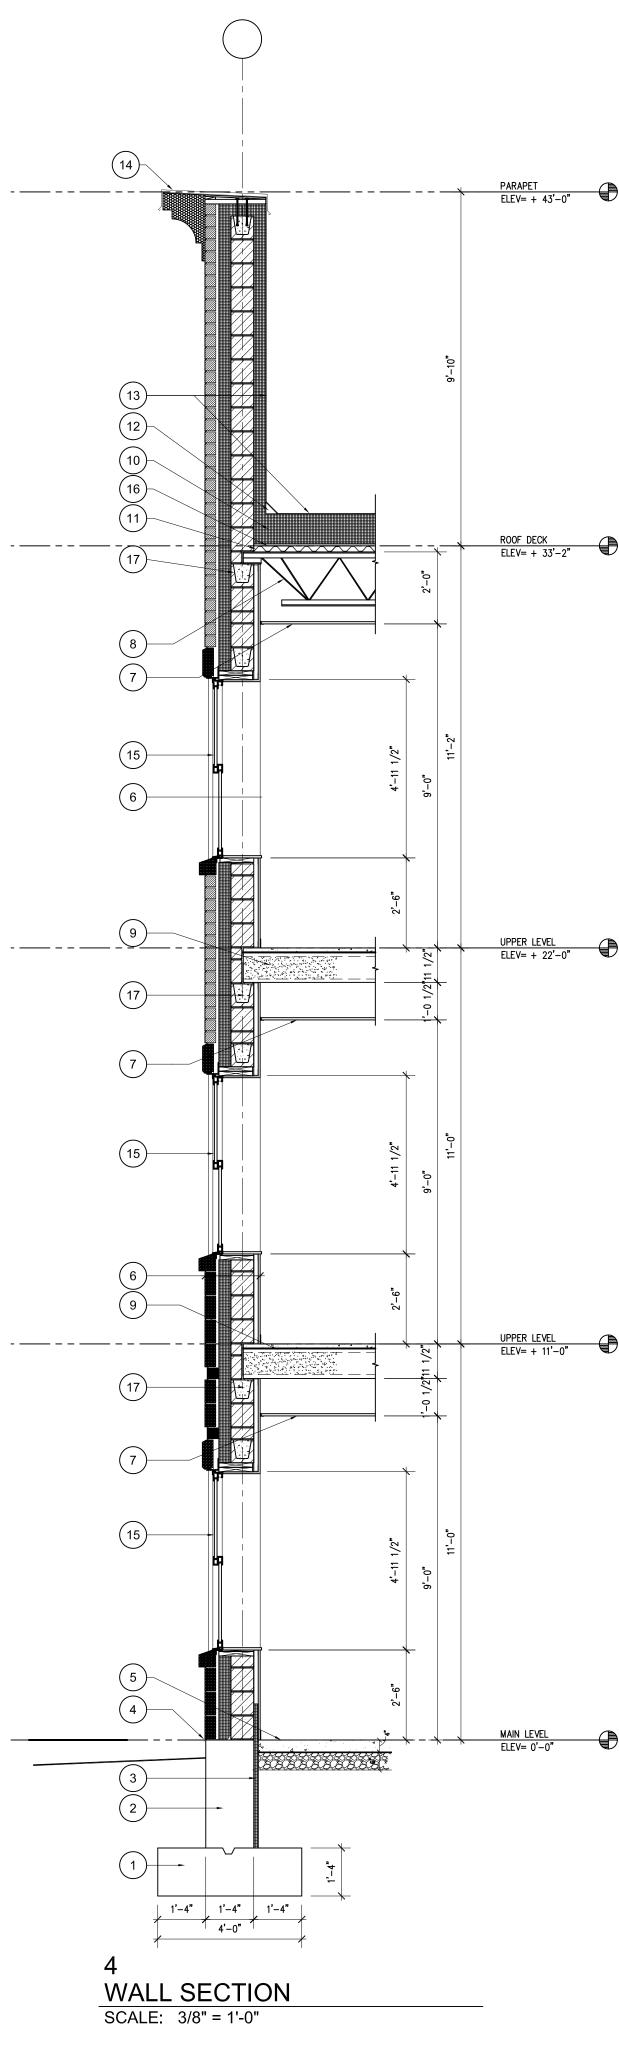

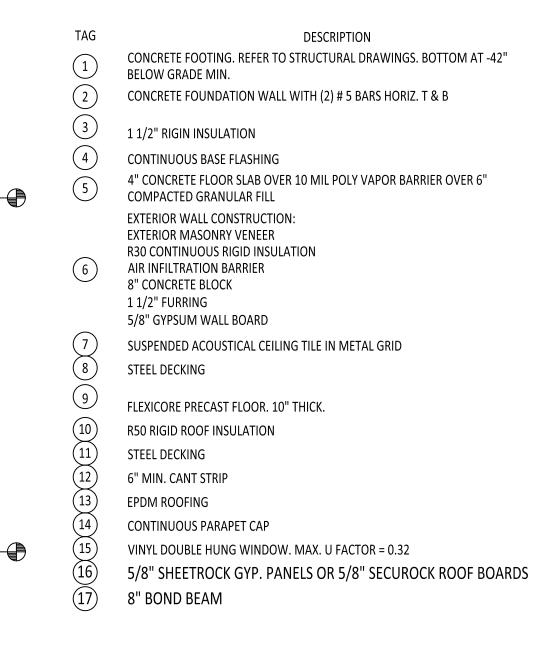PROTECTINE PROTECTION PROTEC





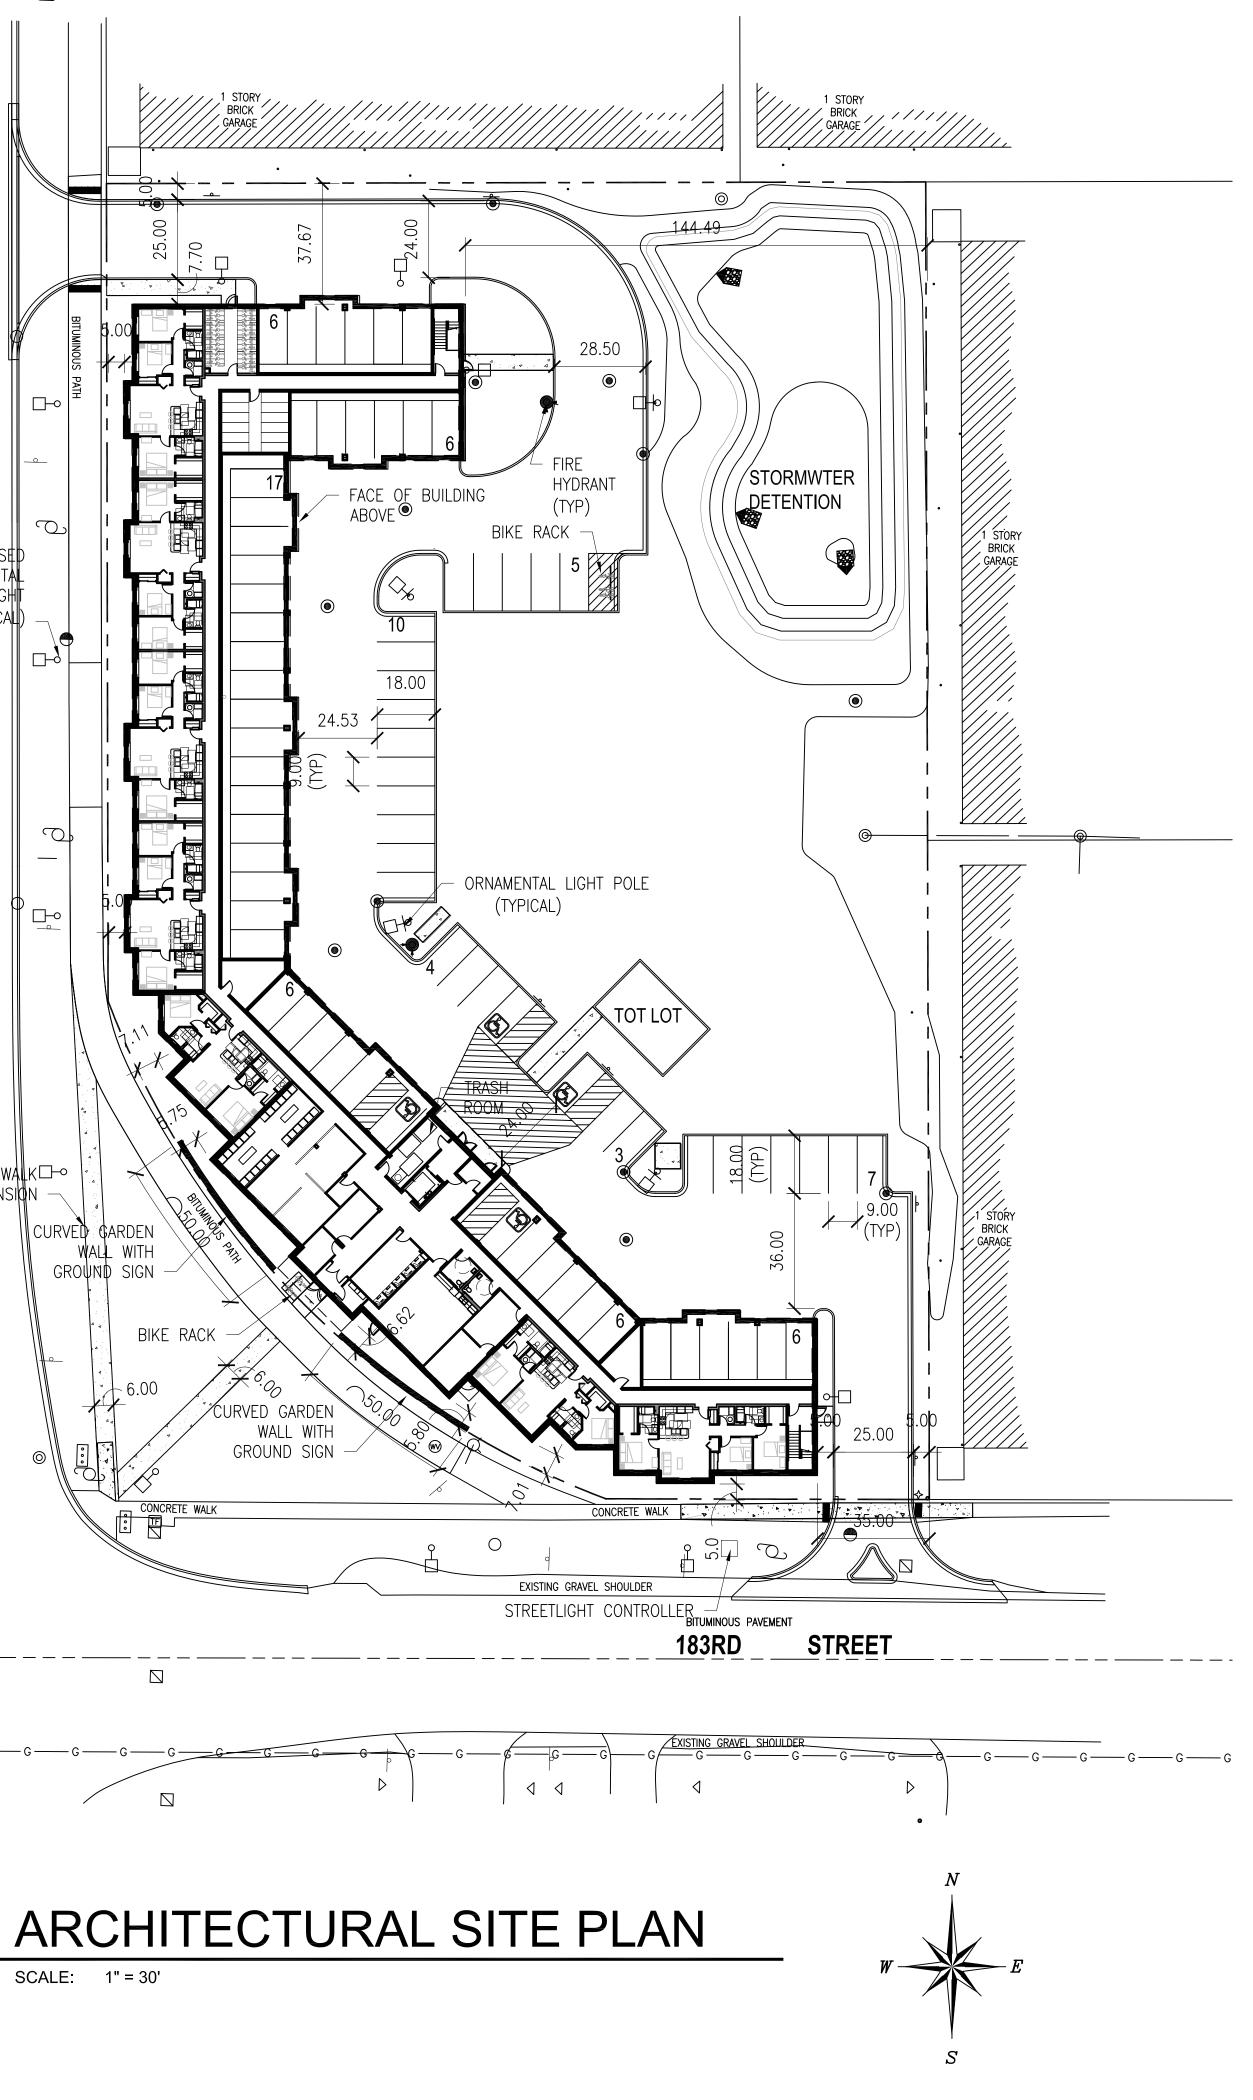

NOTES

		SITE DATA GENERAL			
Frontage:			1		
		583.34			
Gross Site Area:	54. г	96789.56	Acres:	2.22	
	ICOVEF	L RAGE AND DENSITY			
Building Coverage:	28%				
Floor Area Ratio (FAR):	0.83				
Density	21.2	Units per acre			
Landscaped Area:	Sq. Ft:	43109.96	Percent of Site:	45%	
Pavement / Building Area:	Sq. Ft:	53679.6	Percent of Site:	55%	
			Dercent of Darking		
Parking Lot Landscaping	Sq. Ft:	1295.92	Percent of Parking Area:	19.10%	
		PARKING			
		REQUIRED		1	
	Residents	Guests	Administration	Total	
	Units	Units	Sq Ft		
Units or Square Footage	47	47	257		
Ratio/Unit or 1000 sf:	1	0.5	4		
Total Stalls Required:	47	24	2	73	
		PROVIDED			
	Covered	Outside	Total		
Standard	45	27	72		
Accessible	2	2	4	Excess Stalls:	
Total	47	29	76	3	
		AS BY FLOOR	C	Titl	
1st floor	Residential	Circulation	Common	Total 26812	
2nd floor	21335			26812	
3rd floor	21335			26812	
510 11001	21355			20012	
Total of All Floors	50675	0	0	80436	
% / Total Area per Unit	63%	0%	0%	1711	
	UNIT	TYPES BY FLOOR			
	1-Bedroom	2-Bedroom	3-Bedroom	Total All Units	
1st floor	0	2	5	7	
2nd floor	5	4	11	20	
3rd floor			44	20	
	5	4	11		
	5	4		0	
Total of All Floors	5 10	4	27	0 47	
Total of All Floors % of Total Units					
	10	10	27		
% of Total Units	10 21% RENTA	10 21% BLE FLOOR AREA	27 57%		
% of Total Units Unit Type	10 21% RENTA Number of Units	10 21% BLE FLOOR AREA Floor Area per Unit	27		
% of Total Units Unit Type 1-Bedroom Type A	10 21% RENTA	10 21% BLE FLOOR AREA	27 57%		
% of Total Units Unit Type 1-Bedroom Type A 1-Bedroom Type B	10 21% RENTA Number of Units	10 21% BLE FLOOR AREA Floor Area per Unit	27 57% Total Floor Area		
% of Total Units Unit Type 1-Bedroom Type A 1-Bedroom Type B 2-Bedroom Type A	10 21% RENTA Number of Units 6	10 21% BLE FLOOR AREA Floor Area per Unit 828	27 57% Total Floor Area 4968		
% of Total Units Unit Type 1-Bedroom Type A 1-Bedroom Type B 2-Bedroom Type A 2-Bedroom Type B	10 21% RENTA Number of Units 6 4	10 21% BLE FLOOR AREA Floor Area per Unit 828 898	27 57% Total Floor Area 4968 3592		
% of Total Units Unit Type 1-Bedroom Type A 1-Bedroom Type B 2-Bedroom Type A 2-Bedroom Type B 3-Bedroom Type A	10 21% RENTA Number of Units 6 4 4	10 21% BLE FLOOR AREA Floor Area per Unit 828 898 1033	27 57% Total Floor Area 4968 3592 4132		
% of Total Units Unit Type 1-Bedroom Type A 1-Bedroom Type B 2-Bedroom Type A 2-Bedroom Type B	10 21% RENTA Number of Units 6 4 4 6	10 21% BLE FLOOR AREA Floor Area per Unit 828 898 1033 1060	27 57% Total Floor Area 4968 3592 4132 6360		



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	PROJECT: THE RESERVE AT TINLEY PARK NORTHEAST CORNER OF OAK PARK AVENUE AND 183RD ST NORTHEAST CORNER OF OAK PARK AVENUE AND 183RD ST TINLEY PARK, IL CLENT: CLE
	JOB NO. 15–016 DATE 1–27–16 FILE AS1-Architectural Site Plan PLOT SCALE 1:1 OWNER APPROVAL
	Signature Date
I	SHEET TITLE ARCHITECTURAL SITE PLAN
	sheet number AS1

ZONING TABLE Ref: 2011 Legacy Code PRINCIPAL BUILDING DESIGN STANDARDS

			Requirements			
		Units	Current Zoning	Proposed Project		
	Zoning District			borhood Flex		
Zone	Zoning Description		The Neighborhood Flex District consists of a variety of lot sizes and building scales, with buildings designed for residential or commerci uses. Street frontages have steady street tree plantings, and buildin are separated or attached to form a contin-uous street wall set close to sidewalks.			
			1			
Use	Permitted Uses		Owner- and renter-occupied dwelling units located within single-family detached, single-family at-tached, multi-family, and/or mixed-use structures, and including but not limited to senior housing.	Multi-Family Housing		
			ble 2.E.6			
	Minimum Lat Width	-	eneral 20	256		
÷	Minimum Lot Width	ft		256		
Lot	Maximum Lot Width	ft	n/a	411.72		
	Minimum Building Height		2 stories	3 stories		
		Puildir	ng Setbacks			
	Front setback, minimum	ft	5	5		
≥ es	Front setback, maximum	ft	15	13.25		
Primary Frontage	Secondary street setback, minimum	ft	5	5		
Pr Pr	Secondary street setback, minimum	ft	15	6.95		
	Secondary street setback, maximum	1.	15	0.55		
ac	Interior Side Setback, maximum	ft	5	n/a		
Side Setbac k	Access Drive Side Setback, minimum	ft	5	5		
	Rear alley setback, minimum	ft	5	n/a		
Rear Setback	No alley setback, minimum	ft	5	145.22		
Š	Future alley setback, minimum	ft	30	n/a		
	1		g Setbacks	1		
	Front setback, minimum	ft	25	45.74		
Primary Frontage	Front setback, maximum	ft	n/a	n/a		
Prii Froi	Secondary street setback, minimum	ft	10	36.95		
	Secondary street setback, maximum	ft	n/a	n/a		
side Setbac k	Interior Side Setback, maximum	ft	0	n/a		
s, s	Access Drive Side Setback, minimum	ft	5	5		
	Rear alley setback, minimum	ft	5	n/a		
Rear Setback	No alley setback, minimum	ft	5	34.25		
Re Sett	Future alley setback, minimum	ft	30	n/a		
			50	11/ a		
		Alley & Acce	I			
	Alley Rear Yard Setback, minimum		5	n/a		
	Alley Location	-	n/a	n/a		
	Access Road Location	-	As per page 61	1/1/3		
	1	1		1		
	Permitted location of accessory structures		Parking zone	n/a		
	•					